PRELIMINARY PLAT PLANS

TO SERVE

DEER VALLEY SUBDIVISION

A RESIDENTIAL SUBDIVISION

IN

TONTITOWN AND WASHINGTON COUNTY

November 1, 2022

BY

ENGINEERING SERVICES INC.



CONSULTING ENGINEERS
SPRINGDALE, ARKANSAS

PHONE: 479-751-8733

FAX: 479-751-8746

WWW.ENGINEERINGSERVICES.COM

TELIVIIINANI FLAI FLAIN

TELEPHONE COMPANY:

AT&T
CONTACT: JOHN HILL
PH. 479-442-1963
EMAIL: JH7313@ATT.COM

CABLE COMPANY:

GAS COMPANY:

BLACK HILLS ENERGY

CONTACT: BRANDON STOKES

PH. 479-225-3726

ELECTRIC COMPANY: OZARKS ELECTRIC

CONTACT: WES MAHAFFEY
PH. 479-684-4949
EMAIL: WMAHAFFEY@OZARKSECC.COM

COX COMMUNICATION CONTACT: MICHAEL MOORE 4901 SOUTH 48TH STREET

PH: 479-717-3730 FAX: 479-872-0174

SPRINGDALE, AR 72762

EMAIL: MICHAEL.MOORE3@COX.COM

WATER ASSESSED REPARTMENT. TONITIONAL WATER LITERATES

WATER /SEWER DEPARTMENT: TONTITOWN WATER UTILITIES 201 E HENRI DE TONTI BLVD

TONTITOWN, AR 72770 PH. 479–361–2996 FAX: 501–421–8774

PLANNING DEPARTMENT:


PLANNING AND ZONING DEPARTMENT
235 E. HENRI DE TONTI

TONTITOWN, AR 72770 PH. 479-361-9702 FAX 501-421-0012

BUILDING DEPARTMENT: CITY OF TONTITOWN'S BUILDING DEPT.

235 E. HENRI DE TONTI TONTITOWN, AR 72770 PH. 479-361-9702 FAX 501-421-0012



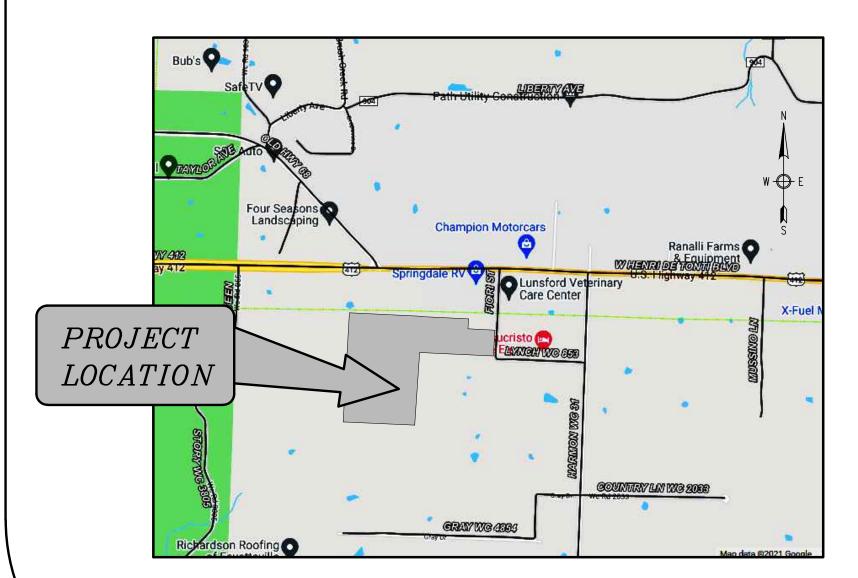

VICINITY MAP

SHEET No.

3-5

6-8

9-10

12

13–15

FLOOD PLAIN ZONING:

NOT FOR CONSTRUCTION

INDEX OF SHEETS

DEMOLITION PLAN

OVERALL SITE PLAN

PRELIMINARY PLAT

TYPICAL DETAILS

UTILITY DETAILS

THIS PROPERTY IS NOT WITHIN A SPECIAL FLOOD ZONE AS SHOWN ON THE F.I.R.M. MAP #05143C0065 F, PANEL 65 OF 575, WASHINGTON COUNTY, ARKANSAS AND INCORPORATED AREAS. EFFECTIVE DATE: MAY 16, 2008.

STREET PLAN AND PROFILES

STORM PLAN AND PROFILES

POND PLANS AND DETAILS

WATER PLAN AND PROFILES

STORM WATER POLLUTION PROTECTION PLAN


STORM WATER POLLUTION PROTECTION DETAILS

DESCRIPTION

THOMAS J. APPEL, P.E. No. 13828 ENGINEERING SERVICES, INC.

NOTES:

- 1. STREET LIGHTS IN SUBDIVISION TO BE A MINIMUM OF 6800 LUMENS.
- 2. ALL LOT CORNER RADII ARE 30' UNLESS OTHERWISE NOTED.
- ANY DAMAGE OR RELOCATION OF EXISTING UTILITIES SHALL BE AT THE DEVELOPER'S EXPENSE.
- 4. ALL CONDUITS PLACED BY DEVELOPER MUST HAVE 48 INCH COVER AT FINAL GRADE. (6-4" CONDUITS FOR ROAD CROSSINGS, ETC.)
- 5. THERE ARE NO KNOWN WETLANDS ON THIS PROPERTY
- 6. NO KNOWN EROSION PROBLEMS EXIST ON THIS SITE NOR DOWNSTREAM OF THE SITE.
- 7. THERE ARE NO KNOW EXISTING OR ABANDONED WATER WELLS, SUMPS, CESSPOOLS, SPRINGS, WATER IMPOUNDMENTS, OR UNDERGROUND STRUCTURES ON THIS PROPERTY.
- 8. THERE ARE NO KNOWN POTENTIALLY DANGEROUS AREAS.
- 9. THERE ARE NO KNOWN EXISTING OR PROPOSED GROUND LEASES OR ACCESS AGREEMENTS.
- 10. NO LOTS MAY ACCESS OFF OF FIORI STREET.
- 11. THERE ARE NO KNOWN OVERFLOW PROBLEMS OF SEWER OR SEPTIC SYSTEMS IN THE SITE OR IN THE PROXIMITY OF THE AREA.
- 12. ALL HOUSES SHALL BE SPRINKLERED IN ACCORDANCE WITH FIRE CODE.
- 13. TEST PIT INFORMATION WILL BE SUBMITTED TO WASHINGTON COUNTY FOR REVIEW.
- 14. A WAIVER FOR BLOCK LENGTH WAS APPROVED ON JUNE 28, 2022 TO ALLOW A STREET THAT EXCEEDS THE MAXIMUM OF 1,500 FEET.
- 15. ALL BACKFILL SHALL BE CLASS 7 BASE, 98% MODIFIED PROCTOR, UNLESS OTHERWISE SPECIFIED. ALL STREETS SHALL BE COMPACTED APPROPRIATELY TO SUPPORT EMERGENCY VEHICLES.

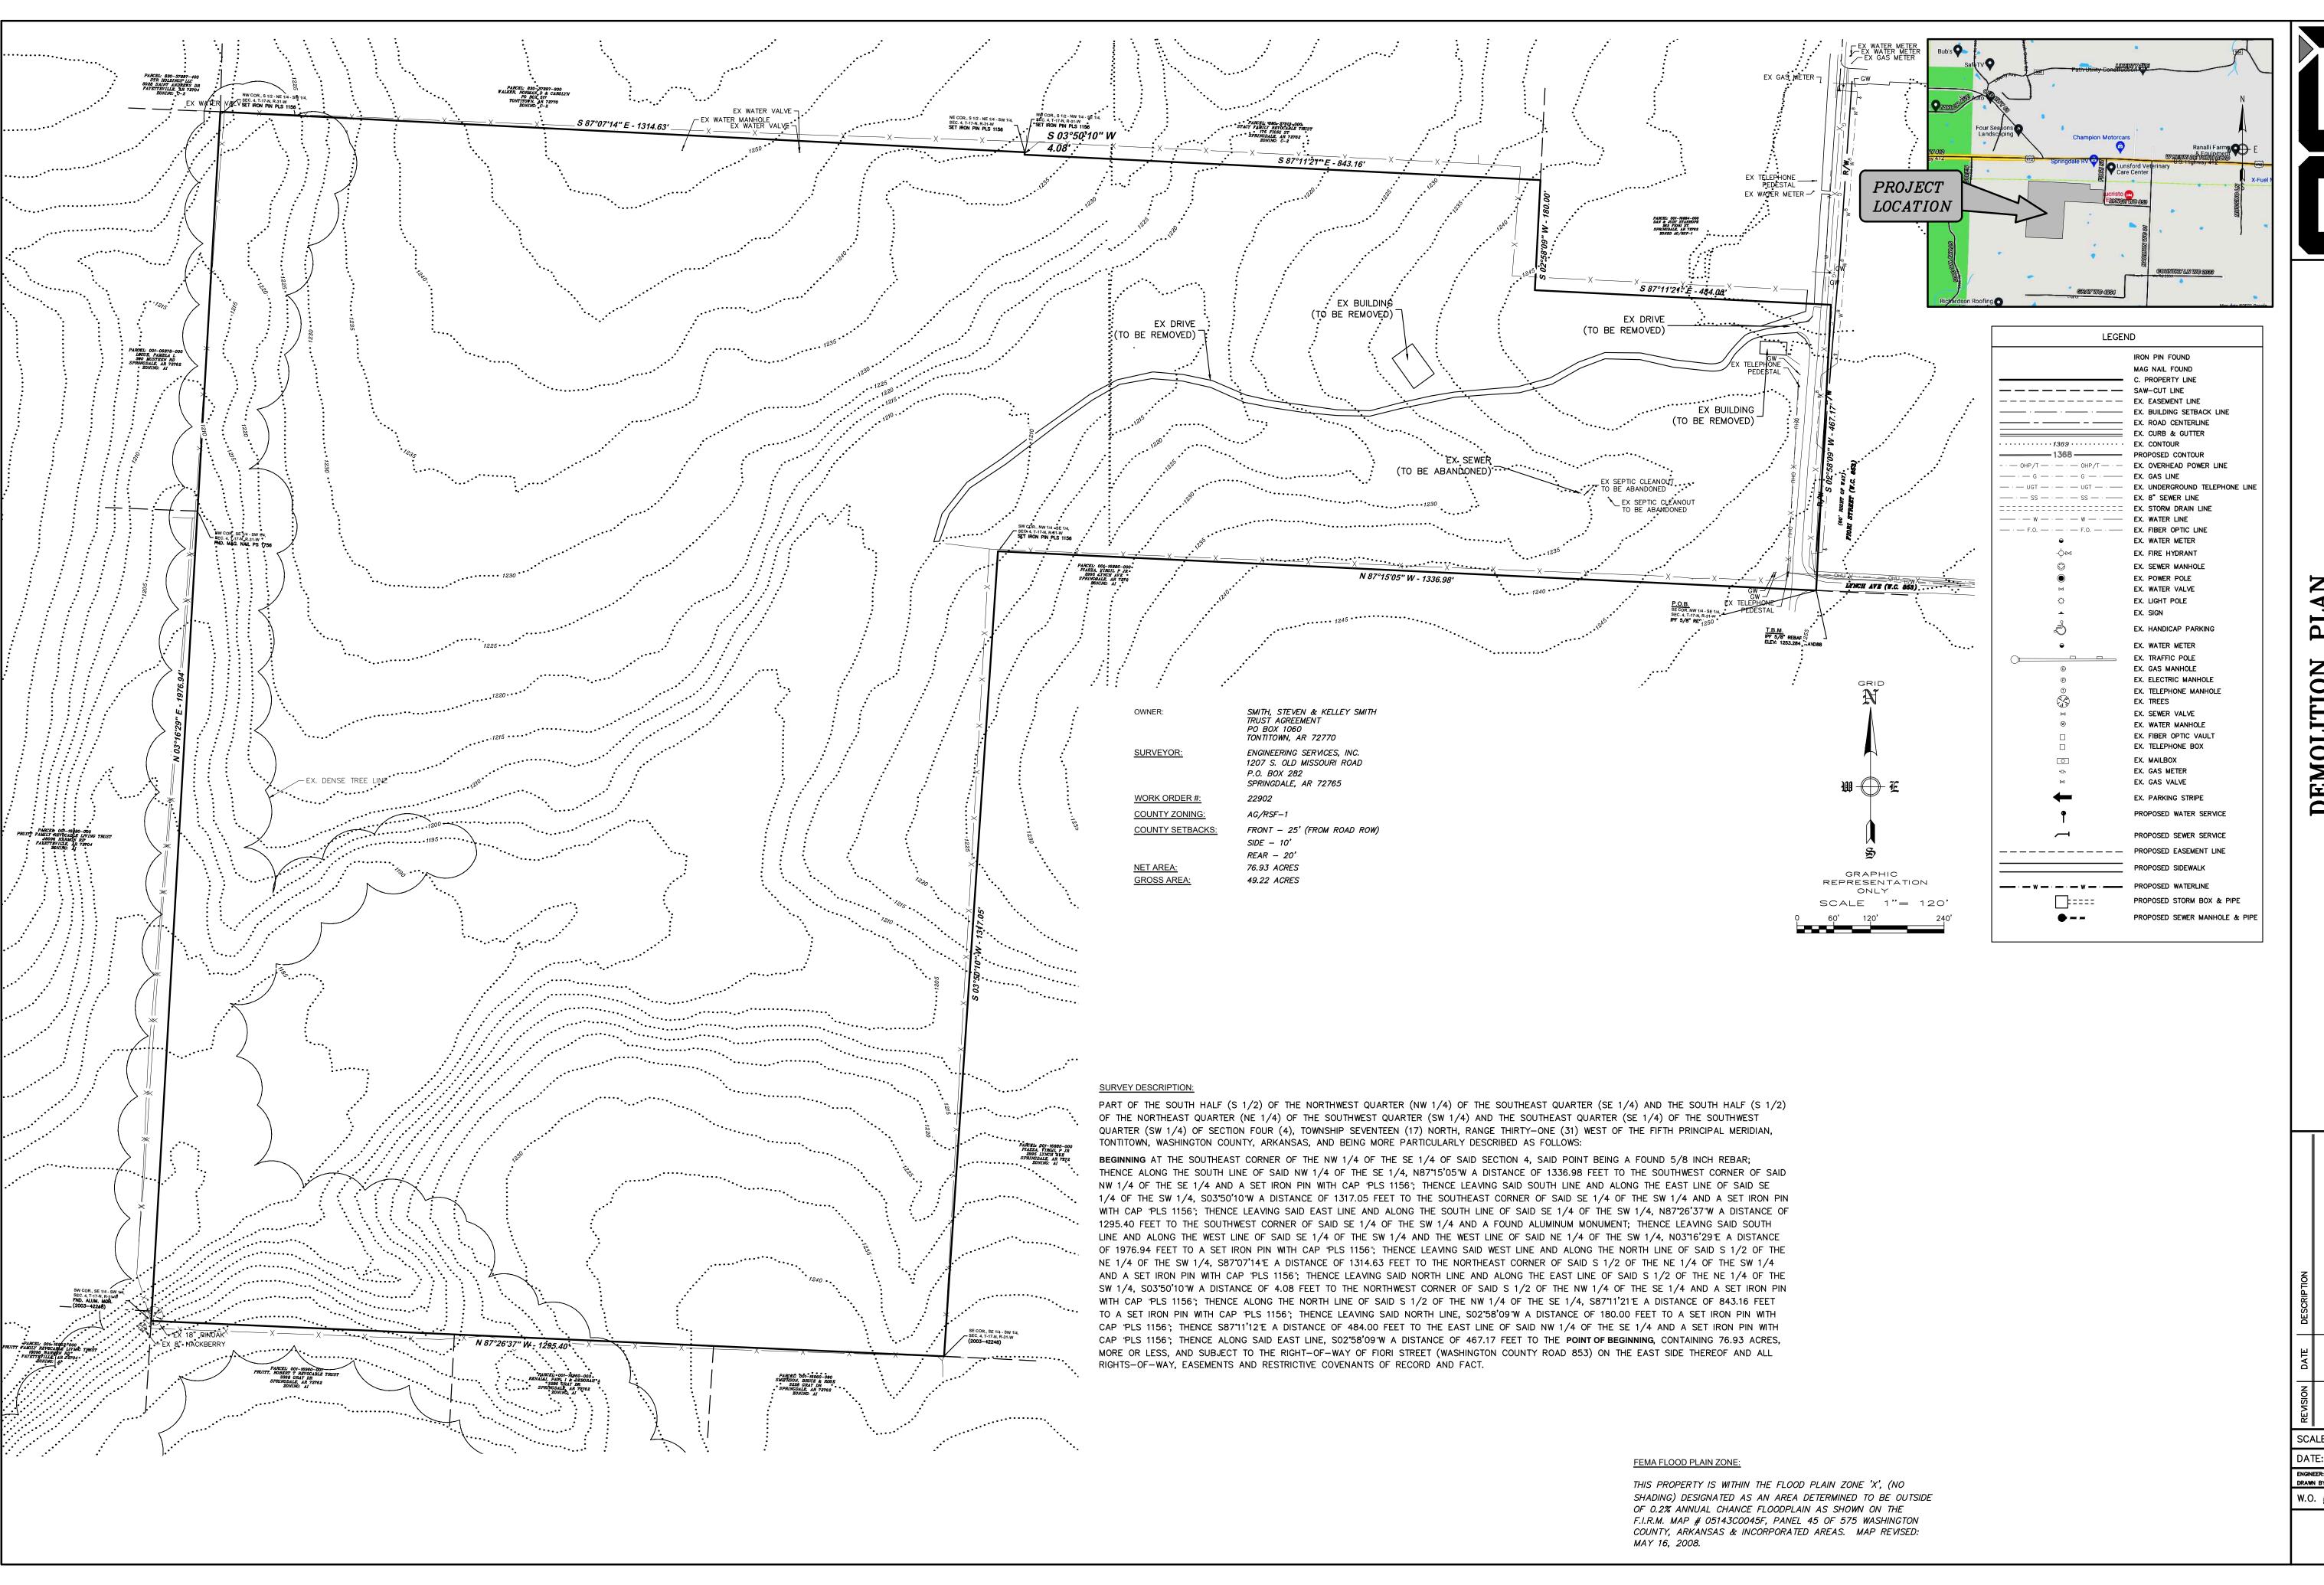

ENGINEERING SERVICES INC.
1207 SOUTH OLD MISSOUR! RD.
SPRINGDALE, ARKANSAS 72764

DEMOLITION PLAN
DEER VALLEY SUBDIVISION
TONTITOWN, ARKANSAS

SCRIPTION

STATE


SCALE: 1"=120'

DATE: Oct 31, 2022

ENGINEER: BAM
DRAWN BY: BAP

ENGINEER: BAM DRAWN BY: BAP

W.O. #: 22902

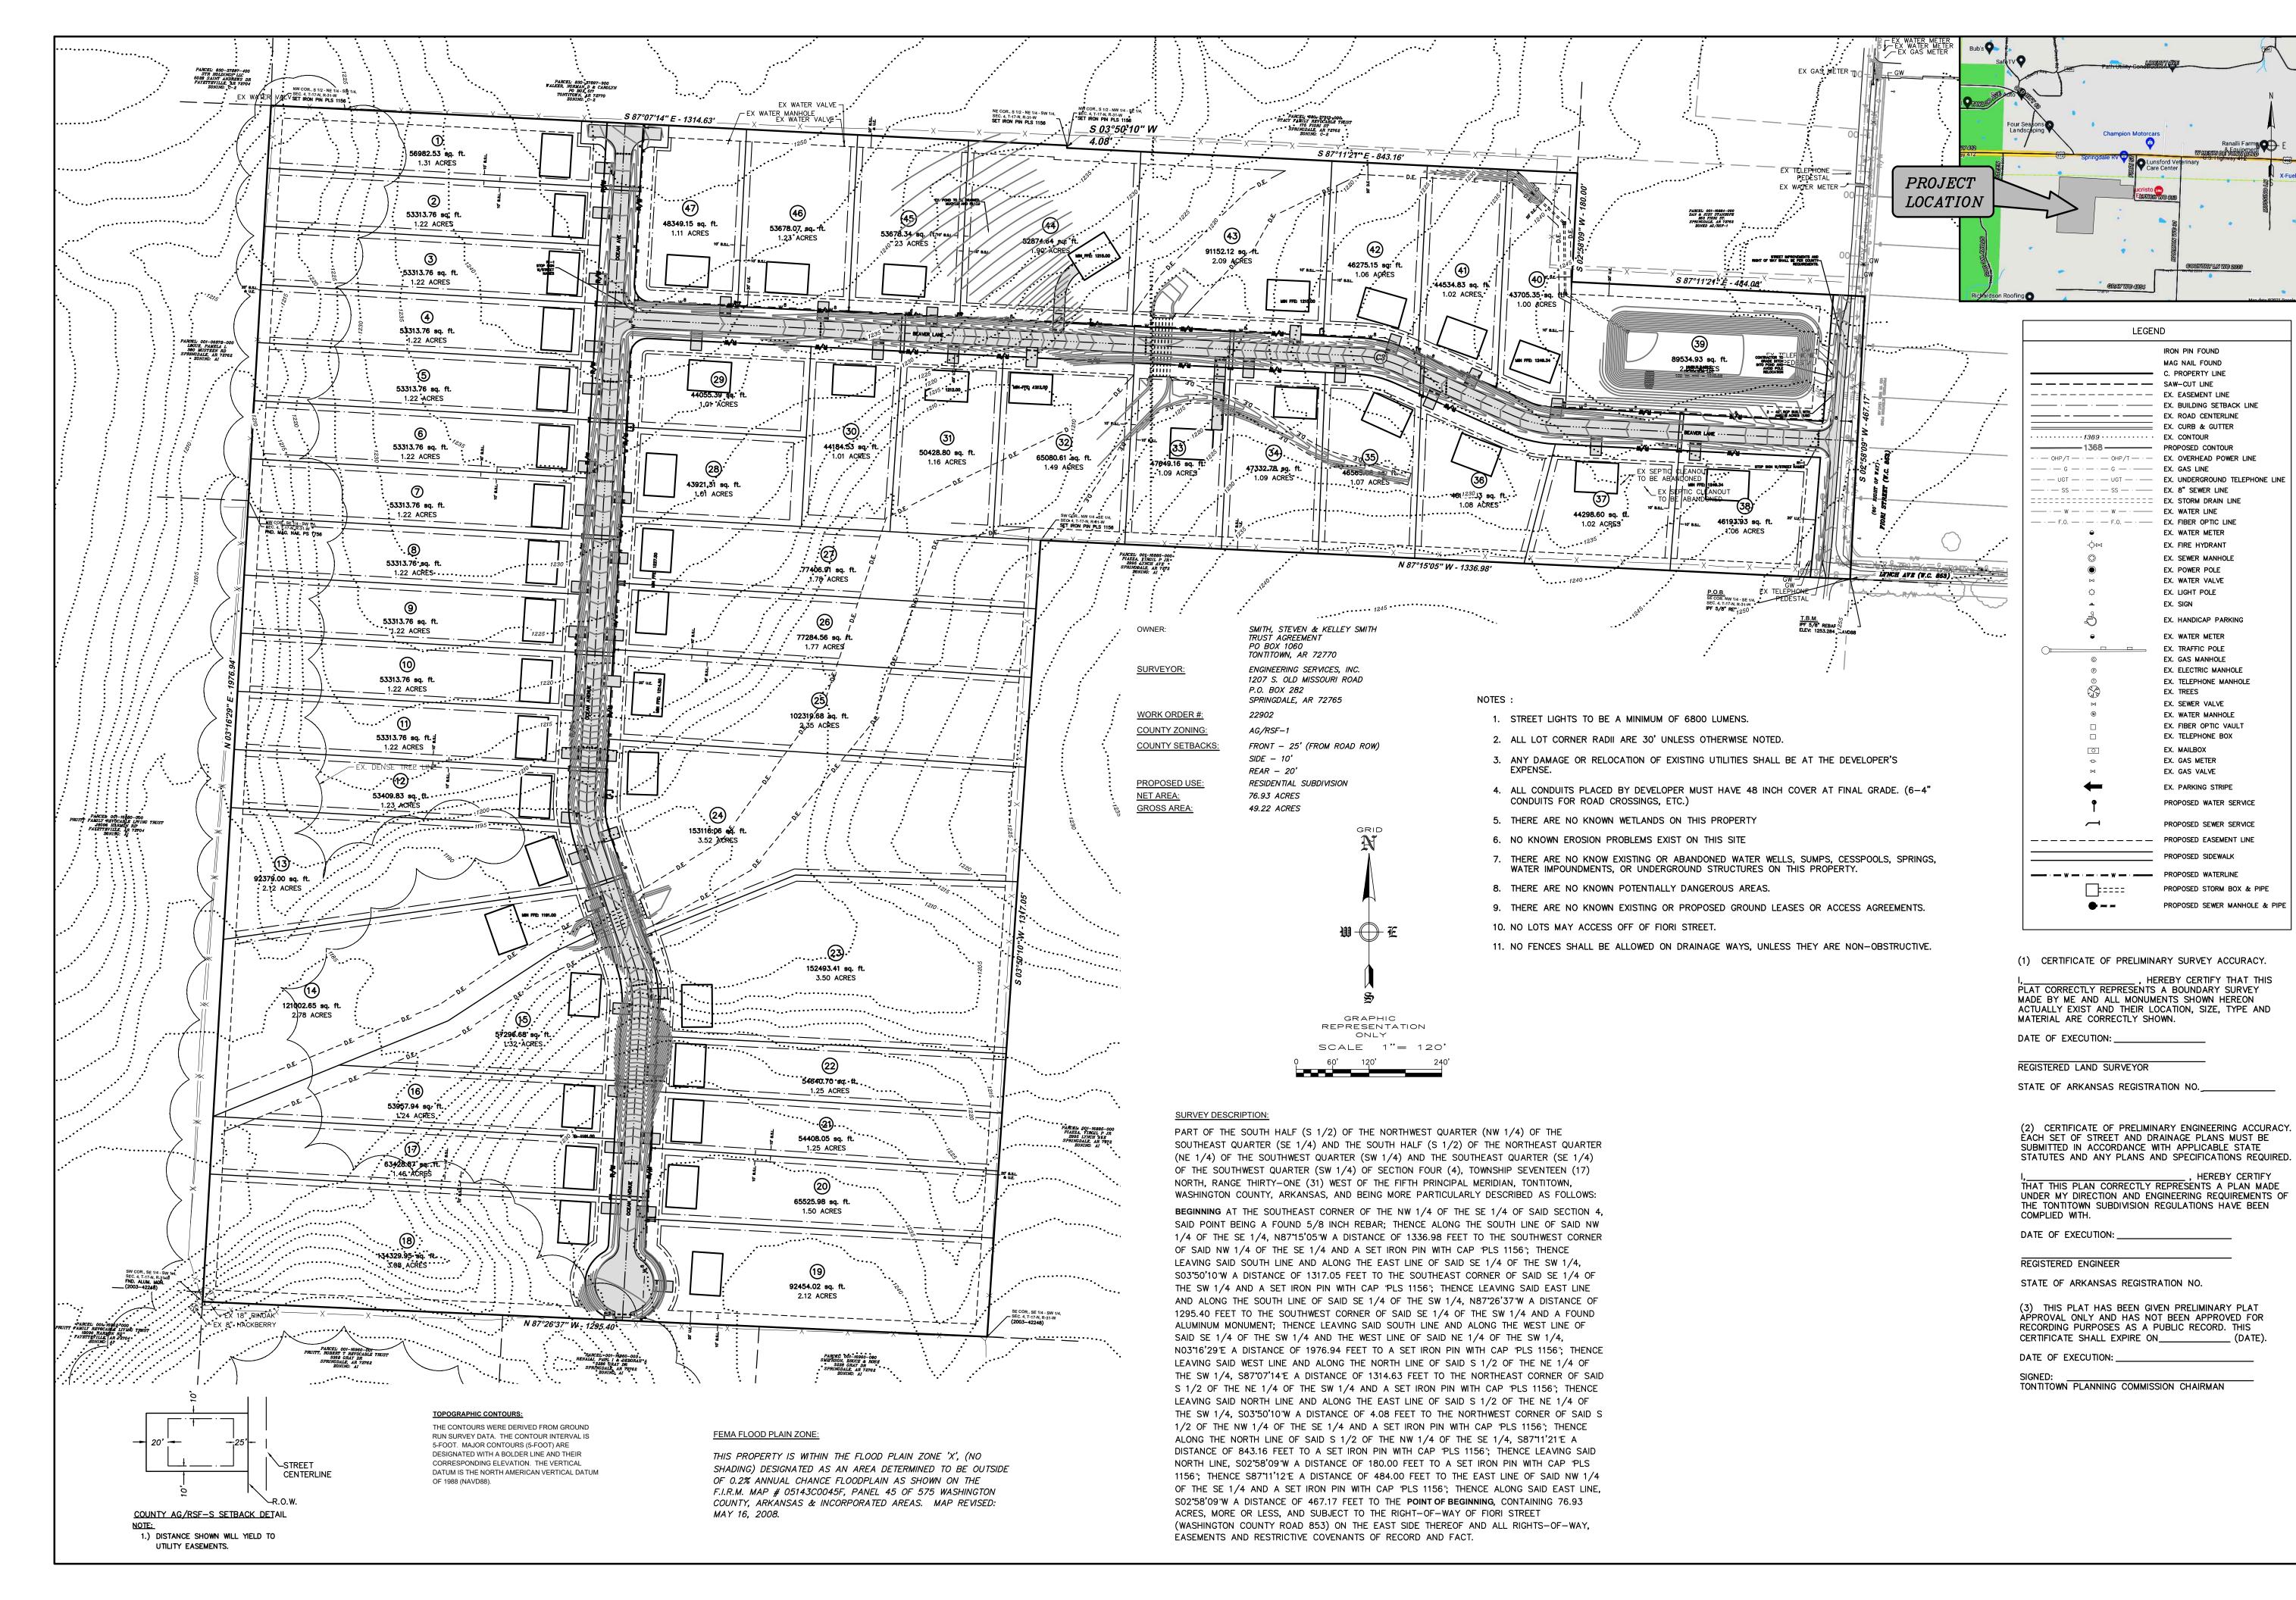


ENGINEERING SERVICES INC.
1207 SOUTH OLD MISSOURI RD.
SPRINGDALE, ARKANSAS 72764

OVERALL SITE PLAN
DEER VALLEY SUBDIVISION
TONTITOWN, ARKANSAS

SCALE: 1"= 120'

© COPYRIGHT ZUZZ, ENGINEERING SERVICES, INC. 10/31/2022 3:34 PM

w.o. #: 22902

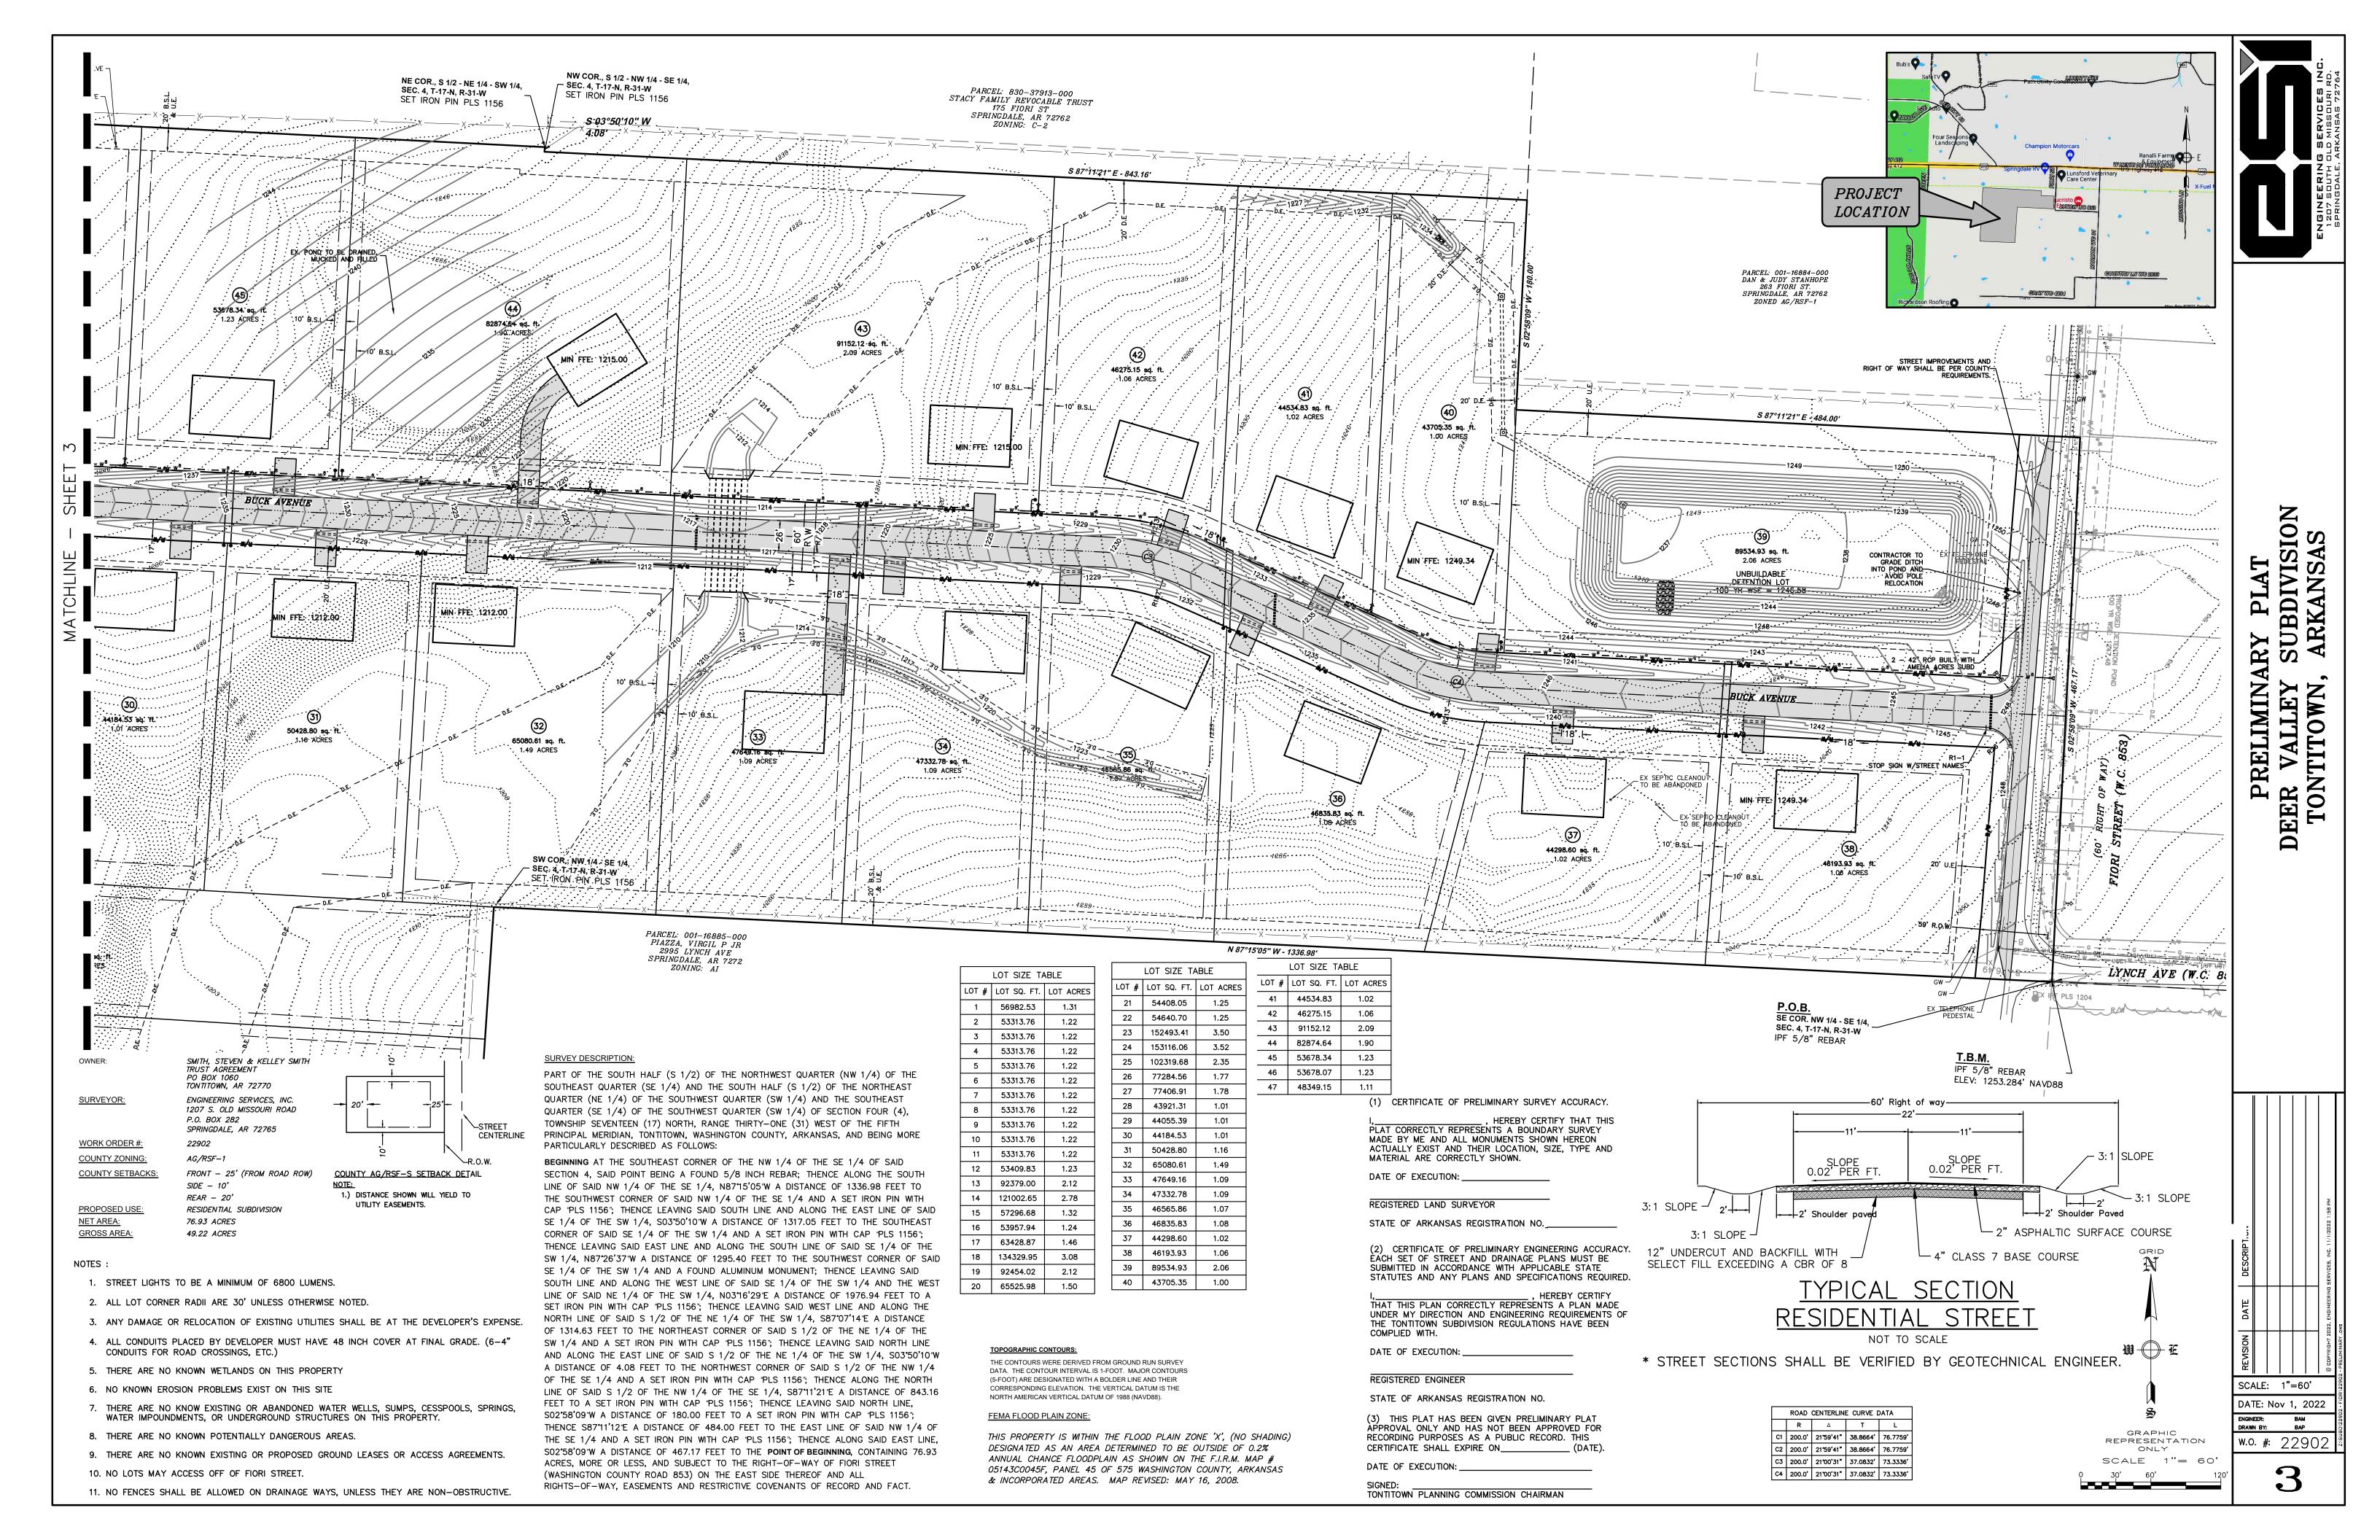

PART OF THE SOUTH HALF (S 1/2) OF THE NORTHWEST QUARTER (NW 1/4) OF THE SOUTHEAST QUARTER (SE 1/4) AND THE SOUTH HALF (S 1/2) OF THE NORTHEAST QUARTER (NE 1/4) OF THE SOUTHWEST QUARTER (SW 1/4) AND THE SOUTHEAST QUARTER (SE 1/4) OF THE SOUTHWEST QUARTER (SW 1/4) OF SECTION FOUR (4), TOWNSHIP SEVENTEEN (17) NORTH, RANGE THIRTY-ONE (31) WEST OF THE FIFTH PRINCIPAL MERIDIAN, TONTITOWN, WASHINGTON COUNTY, ARKANSAS, AND BEING MORE PARTICULARLY DESCRIBED AS FOLLOWS:

BEGINNING AT THE SOUTHEAST CORNER OF THE NW 1/4 OF THE SE 1/4 OF SAID SECTION 4, SAID POINT BEING A FOUND 5/8 INCH REBAR; THENCE ALONG THE SOUTH LINE OF SAID NW 1/4 OF THE SE 1/4, N87"15"O5"W A DISTANCE OF 1336.98 FEET TO THE SOUTHWEST CORNER OF SAID NW 1/4 OF THE SE 1/4 AND A SET IRON PIN WITH CAP "PLS 1156"; THENCE LEAVING SAID SOUTH LINE AND ALONG THE EAST LINE OF SAID SE 1/4 OF THE SW 1/4, SO3°50'10"W A DISTANCE OF 1317.05 FEET TO THE SOUTHEAST CORNER OF SAID SE 1/4 OF THE SW 1/4 AND A SET IRON PIN WITH CAP "PLS 1156"; THENCE LEAVING SAID EAST LINE AND ALONG THE SOUTH LINE OF SAID SE 1/4 OF THE SW 1/4, N87'26'37"W A DISTANCE OF 1295.40 FEET TO THE SOUTHWEST CORNER OF SAID SE 1/4 OF THE SW 1/4 AND A FOUND ALUMINUM MONUMENT; THENCE LEAVING SAID SOUTH LINE AND ALONG THE WEST LINE OF SAID SE 1/4 OF THE SW 1/4 AND THE WEST LINE OF SAID NE 1/4 OF THE SW 1/4, NO3"16'29'E A DISTANCE OF 1976.94 FEET TO A SET IRON PIN WITH CAP "PLS 1156"; THENCE LEAVING SAID WEST LINE AND ALONG THE NORTH LINE OF SAID S 1/2 OF THE NE 1/4 OF THE SW 1/4, S87°07'14"E A DISTANCE OF 1314.63 FEET TO THE NORTHEAST CORNER OF SAID S 1/2 OF THE NE 1/4 OF THE SW 1/4 AND A SET IRON PIN WITH CAP "PLS 1156"; THENCE LEAVING SAID NORTH LINE AND ALONG THE EAST LINE OF SAID S 1/2 OF THE NE 1/4 OF THE SW 1/4, S03°50'10"W A DISTANCE OF 4.08 FEET TO THE NORTHWEST CORNER OF SAID S 1/2 OF THE NW 1/4 OF THE SE 1/4 AND A SET IRON PIN WITH CAP "PLS 1156"; THENCE ALONG THE NORTH LINE OF SAID S 1/2 OF THE NW 1/4 OF THE SE 1/4, S87"11"21"E A DISTANCE OF 843.16 FEET TO A SET IRON PIN WITH CAP 'PLS 1156"; THENCE LEAVING SAID NORTH LINE, S02*58'09"W A DISTANCE OF 180.00 FEET TO A SET IRON PIN WITH CAP "PLS 1156"; THENCE S87'11'12'E A DISTANCE OF 484.00 FEET TO THE EAST LINE OF SAID NW 1/4 OF THE SE 1/4 AND A SET IRON PIN WITH CAP "PLS 1156"; THENCE ALONG SAID EAST LINE, SO2°58'09"W A DISTANCE OF 467.17 FEET TO THE **POINT OF BEGINNING,** CONTAINING 76.93 ACRES, MORE OR LESS, AND SUBJECT TO THE RIGHT-OF-WAY OF FIORI STREET (WASHINGTON COUNTY ROAD 853) ON THE EAST SIDE THEREOF AND ALL RIGHTS-OF-WAY, EASEMENTS AND RESTRICTIVE COVENANTS OF RECORD AND FACT.

- 1. STREET LIGHTS TO BE A MINIMUM OF 6800 LUMENS.
- 2. ALL LOT CORNER RADII ARE 30' UNLESS OTHERWISE NOTED.
- 3. ANY DAMAGE OR RELOCATION OF EXISTING UTILITIES SHALL BE AT THE DEVELOPER'S
- 4. ALL CONDUITS PLACED BY DEVELOPER MUST HAVE 48 INCH COVER AT FINAL GRADE. (6-4" CONDUITS FOR ROAD CROSSINGS, ETC.)
- 5. THERE ARE NO KNOWN WETLANDS ON THIS PROPERTY
- 6. NO KNOWN EROSION PROBLEMS EXIST ON THIS SITE
- THERE ARE NO KNOW EXISTING OR ABANDONED WATER WELLS, SUMPS, CESSPOOLS, SPRINGS, WATER IMPOUNDMENTS, OR UNDERGROUND STRUCTURES ON THIS PROPERTY.
- 8. THERE ARE NO KNOWN POTENTIALLY DANGEROUS AREAS.
- 9. THERE ARE NO KNOWN EXISTING OR PROPOSED GROUND LEASES OR ACCESS
- 10. NO LOTS MAY ACCESS OFF OF FIORI STREET.
- 11. NO FENCES SHALL BE ALLOWED ON DRAINAGE WAYS, UNLESS THEY ARE NON-OBSTRUCTIVE.
- (1) CERTIFICATE OF PRELIMINARY SURVEY ACCURACY.

HEREBY CERTIFY THAT THIS PLAT CORRECTLY REPRESENTS A BOUNDARY SURVEY MADE BY ME AND ALL MONUMENTS SHOWN HEREON ACTUALLY EXIST AND THEIR LOCATION, SIZE, TYPE AND

DATE OF EXECUTION:

STATE OF ARKANSAS REGISTRATION NO.

(2) CERTIFICATE OF PRELIMINARY ENGINEERING ACCURACY. EACH SET OF STREET AND DRAINAGE PLANS MUST BE

THAT THIS PLAN CORRECTLY REPRESENTS A PLAN MADE

UNDER MY DIRECTION AND ENGINEERING REQUIREMENTS OF THE TONTITOWN SUBDIVISION REGULATIONS HAVE BEEN COMPLIED WITH.

DATE OF EXECUTION: ____

REGISTERED ENGINEER

STATE OF ARKANSAS REGISTRATION NO.

(3) THIS PLAT HAS BEEN GIVEN PRELIMINARY PLAT APPROVAL ONLY AND HAS NOT BEEN APPROVED FOR RECORDING PURPOSES AS A PUBLIC RECORD. THIS CERTIFICATE SHALL EXPIRE ON______ (DATE).

DATE OF EXECUTION: _

TONTITOWN PLANNING COMMISSION CHAIRMAN

| LOT SIZE TABLE | | | LOT SIZE TABLE | | | |
|----------------|-------------|-----------|----------------|-------------|-----------|--|
| LOT # | LOT SQ. FT. | LOT ACRES | LOT # | LOT SQ. FT. | LOT ACRES | |
| 1 | 56982.53 | 1.31 | 21 | 54408.05 | 1.25 | |
| 2 | 53313.76 | 1.22 | 22 | 54640.70 | 1.25 | |
| 3 | 53313.76 | 1.22 | 23 | 152493.41 | 3.50 | |
| 4 | 53313.76 | 1.22 | 24 | 153116.06 | 3.52 | |
| 5 | 53313.76 | 1.22 | 25 | 102319.68 | 2.35 | |
| 6 | 53313.76 | 1.22 | 26 | 77284.56 | 1.77 | |
| 7 | 53313.76 | 1.22 | 27 | 77406.91 | 1.78 | |
| 8 | 53313.76 | 1.22 | 28 | 43921.31 | 1.01 | |
| 9 | 53313.76 | 1.22 | 29 | 44055.39 | 1.01 | |
| 10 | 53313.76 | 1.22 | 30 | 44184.53 | 1.01 | |
| 11 | 53313.76 | 1.22 | 31 | 50428.80 | 1.16 | |
| 12 | 53409.83 | 1.23 | 32 | 65080.61 | 1.49 | |
| 13 | 92379.00 | 2.12 | 33 | 47649.16 | 1.09 | |
| 14 | 121002.65 | 2.78 | 34 | 47332.78 | 1.09 | |
| 15 | 57296.68 | 1.32 | 35 | 46565.86 | 1.07 | |
| 16 | 53957.94 | 1.24 | 36 | 46835.83 | 1.08 | |
| 17 | 63428.87 | 1.46 | 37 | 44298.60 | 1.02 | |
| 18 | 134329.95 | 3.08 | 38 | 46193.93 | 1.06 | |
| 19 | 92454.02 | 2.12 | 39 | 89534.93 | 2.06 | |

20 65525.98

40 | 43705.35 | 1.00

| Bub's Safe TV | Path Utility Constitution | | | |
|--------------------------|---|--|--|--|
| Four Seasons Landscaping | Champion Motorcars Ranalli Farma 8 Foul Proceedings 19 1 1 1 1 1 1 1 1 1 1 1 1 1 1 1 1 1 1 | | | |
| | Care Center Lunsford Veterinary Care Center | | | |
| PROJECT | | | | |
| LOCATION | Leristo (2) FEAXURITURE (50) | | | |
| SILVERTON | WASAMINION VOG SA | | | |
| Richardson Roofing | GRAN WG 4563 GRAN WG 4563 Man data 62021 Goodle | | | |
| OWNER: | SMITH, STEVEN & KELLEY SMITH TRUST AGREEMENT PO BOX 1060 TONTITOWN, AR 72770 | | | |
| SURVEYOR: | ENGINEERING SERVICES, INC. 1207 S. OLD MISSOURI ROAD P.O. BOX 282 SPRINGDALE, AR 72765 | | | |

WORK ORDER #: 22902

COUNTY ZONING: AG/RSF-1 **COUNTY SETBACKS:** FRONT - 25' (FROM ROAD ROW)

SIDE - 10' REAR - 20'


RESIDENTIAL SUBDIVISION PROPOSED USE: 76.93 ACRES NET AREA:

GROSS AREA: 49.22 ACRES

FEMA FLOOD PLAIN ZONE

THIS PROPERTY IS WITHIN THE FLOOD PLAIN ZONE 'X', (NO SHADING) DESIGNATED AS AN AREA DETERMINED TO BE OUTSIDE OF 0.2% ANNUAL CHANCE FLOODPLAIN AS SHOWN ON THE F.I.R.M. MAP # 05143C0045F, PANEL 45 OF 575 WASHINGTON COUNTY, ARKANSAS & INCORPORATED AREAS. MAP REVISED: MAY 16, 2008.


THE CONTOURS WERE DERIVED FROM GROUND RUN SURVEY DATA. THE CONTOUR INTERVAL IS 1-FOOT. MAJOR CONTOURS (5-FOOT) ARE DESIGNATED WITH A BOLDER LINE AND THEIR CORRESPONDING ELEVATION. THE VERTICAL DATUM IS THE NORTH AMERICAN VERTICAL DATUM OF 1988 (NAVD88).

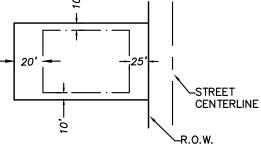



COUNTY AG/RSF-S SETBACK DETAIL 1.) DISTANCE SHOWN WILL YIELD TO UTILITY EASEMENTS.

> LOT SIZE TABLE LOT # LOT SQ. FT. LOT ACRES 41 44534.83 42 46275.15 1.06 43 91152.12 2.09 44 82874.64 1.90 45 53678.34 1.23 46 53678.07 1.23 47 48349.15

| ROAD CENTERLINE CURVE DATA | | | | | | |
|----------------------------|-----------|--------|----|--|--|--|
| T | Δ | R | | | | |
| 9'41" 38.8664' 7 | 21°59'41" | 200.0 | C1 | | | |
| 9'41" 38.8664' 7 | 21°59'41" | 200.0' | C2 | | | |
| 37.0832' 7 | 21°00'31" | 200.0' | С3 | | | |
| 37.0832' 7 | 21°00'31" | 200.0 | C4 | | | |
| 0'31" 37.0832' 7 | 21°00'31" | | | | | |

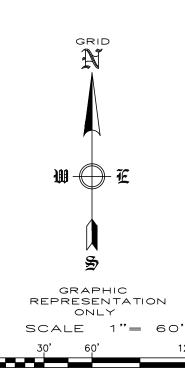

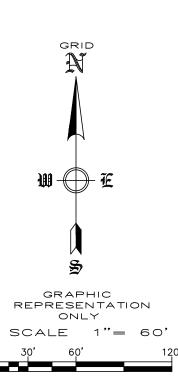

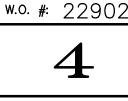

SCALE: 1"=60'


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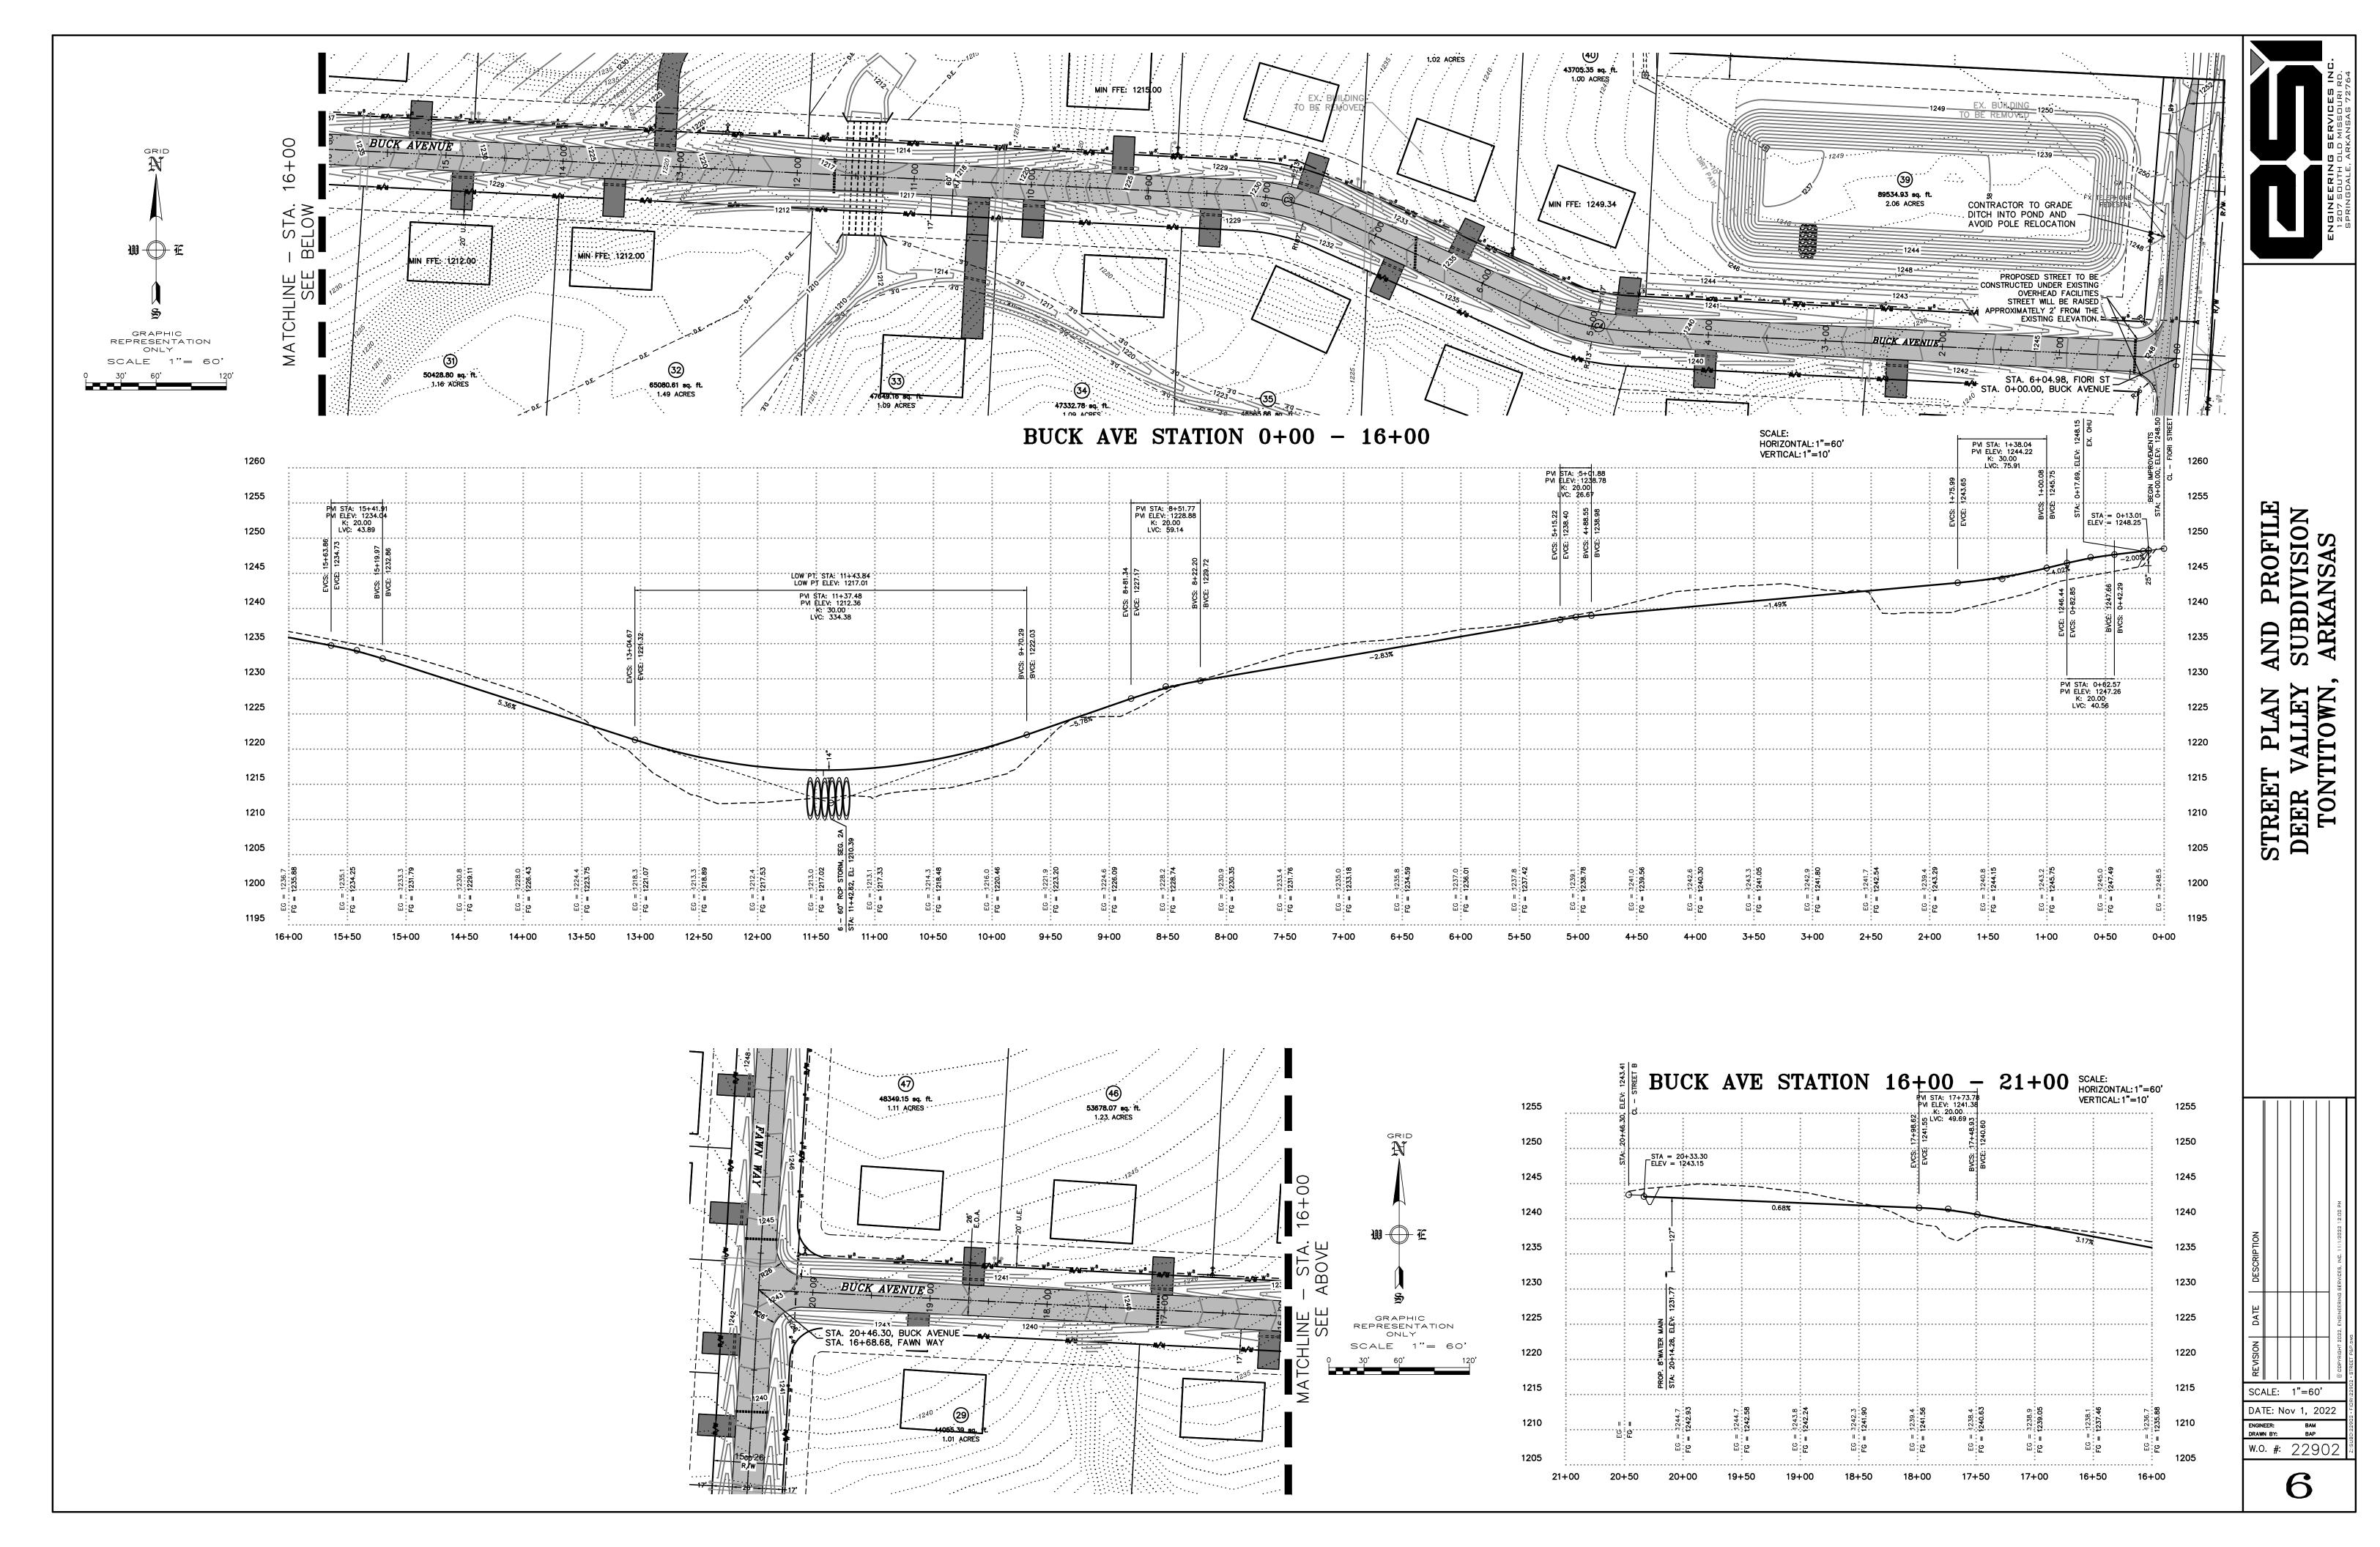
'IBDIVISION REANSAS


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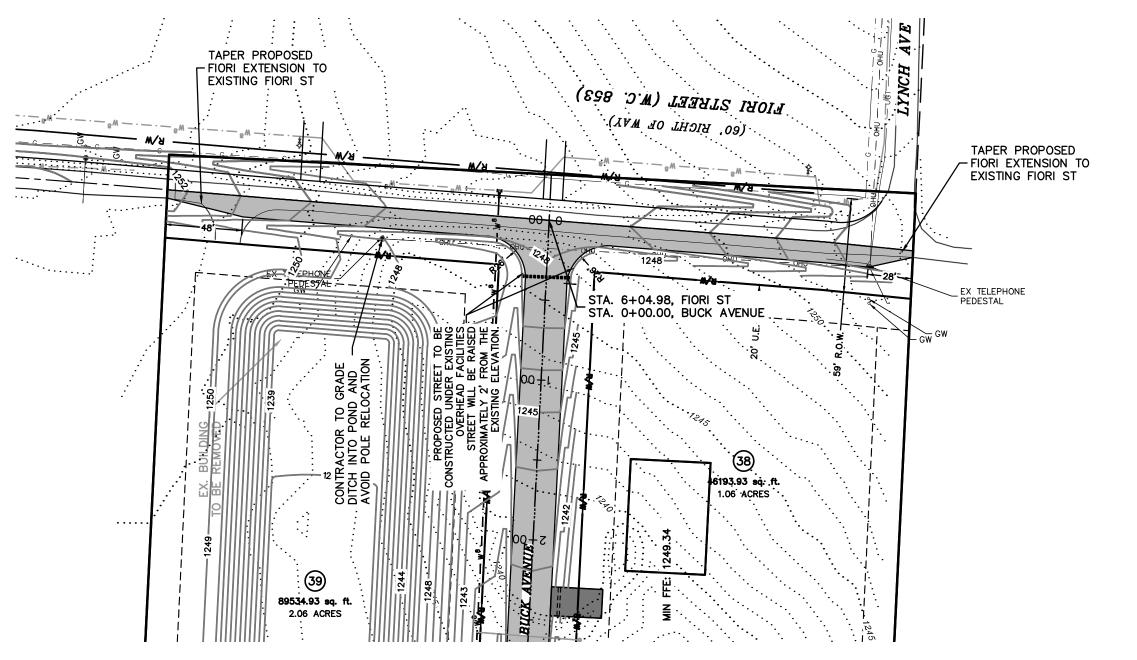









AND PROFILE SUBDIVISION ARKANSAS

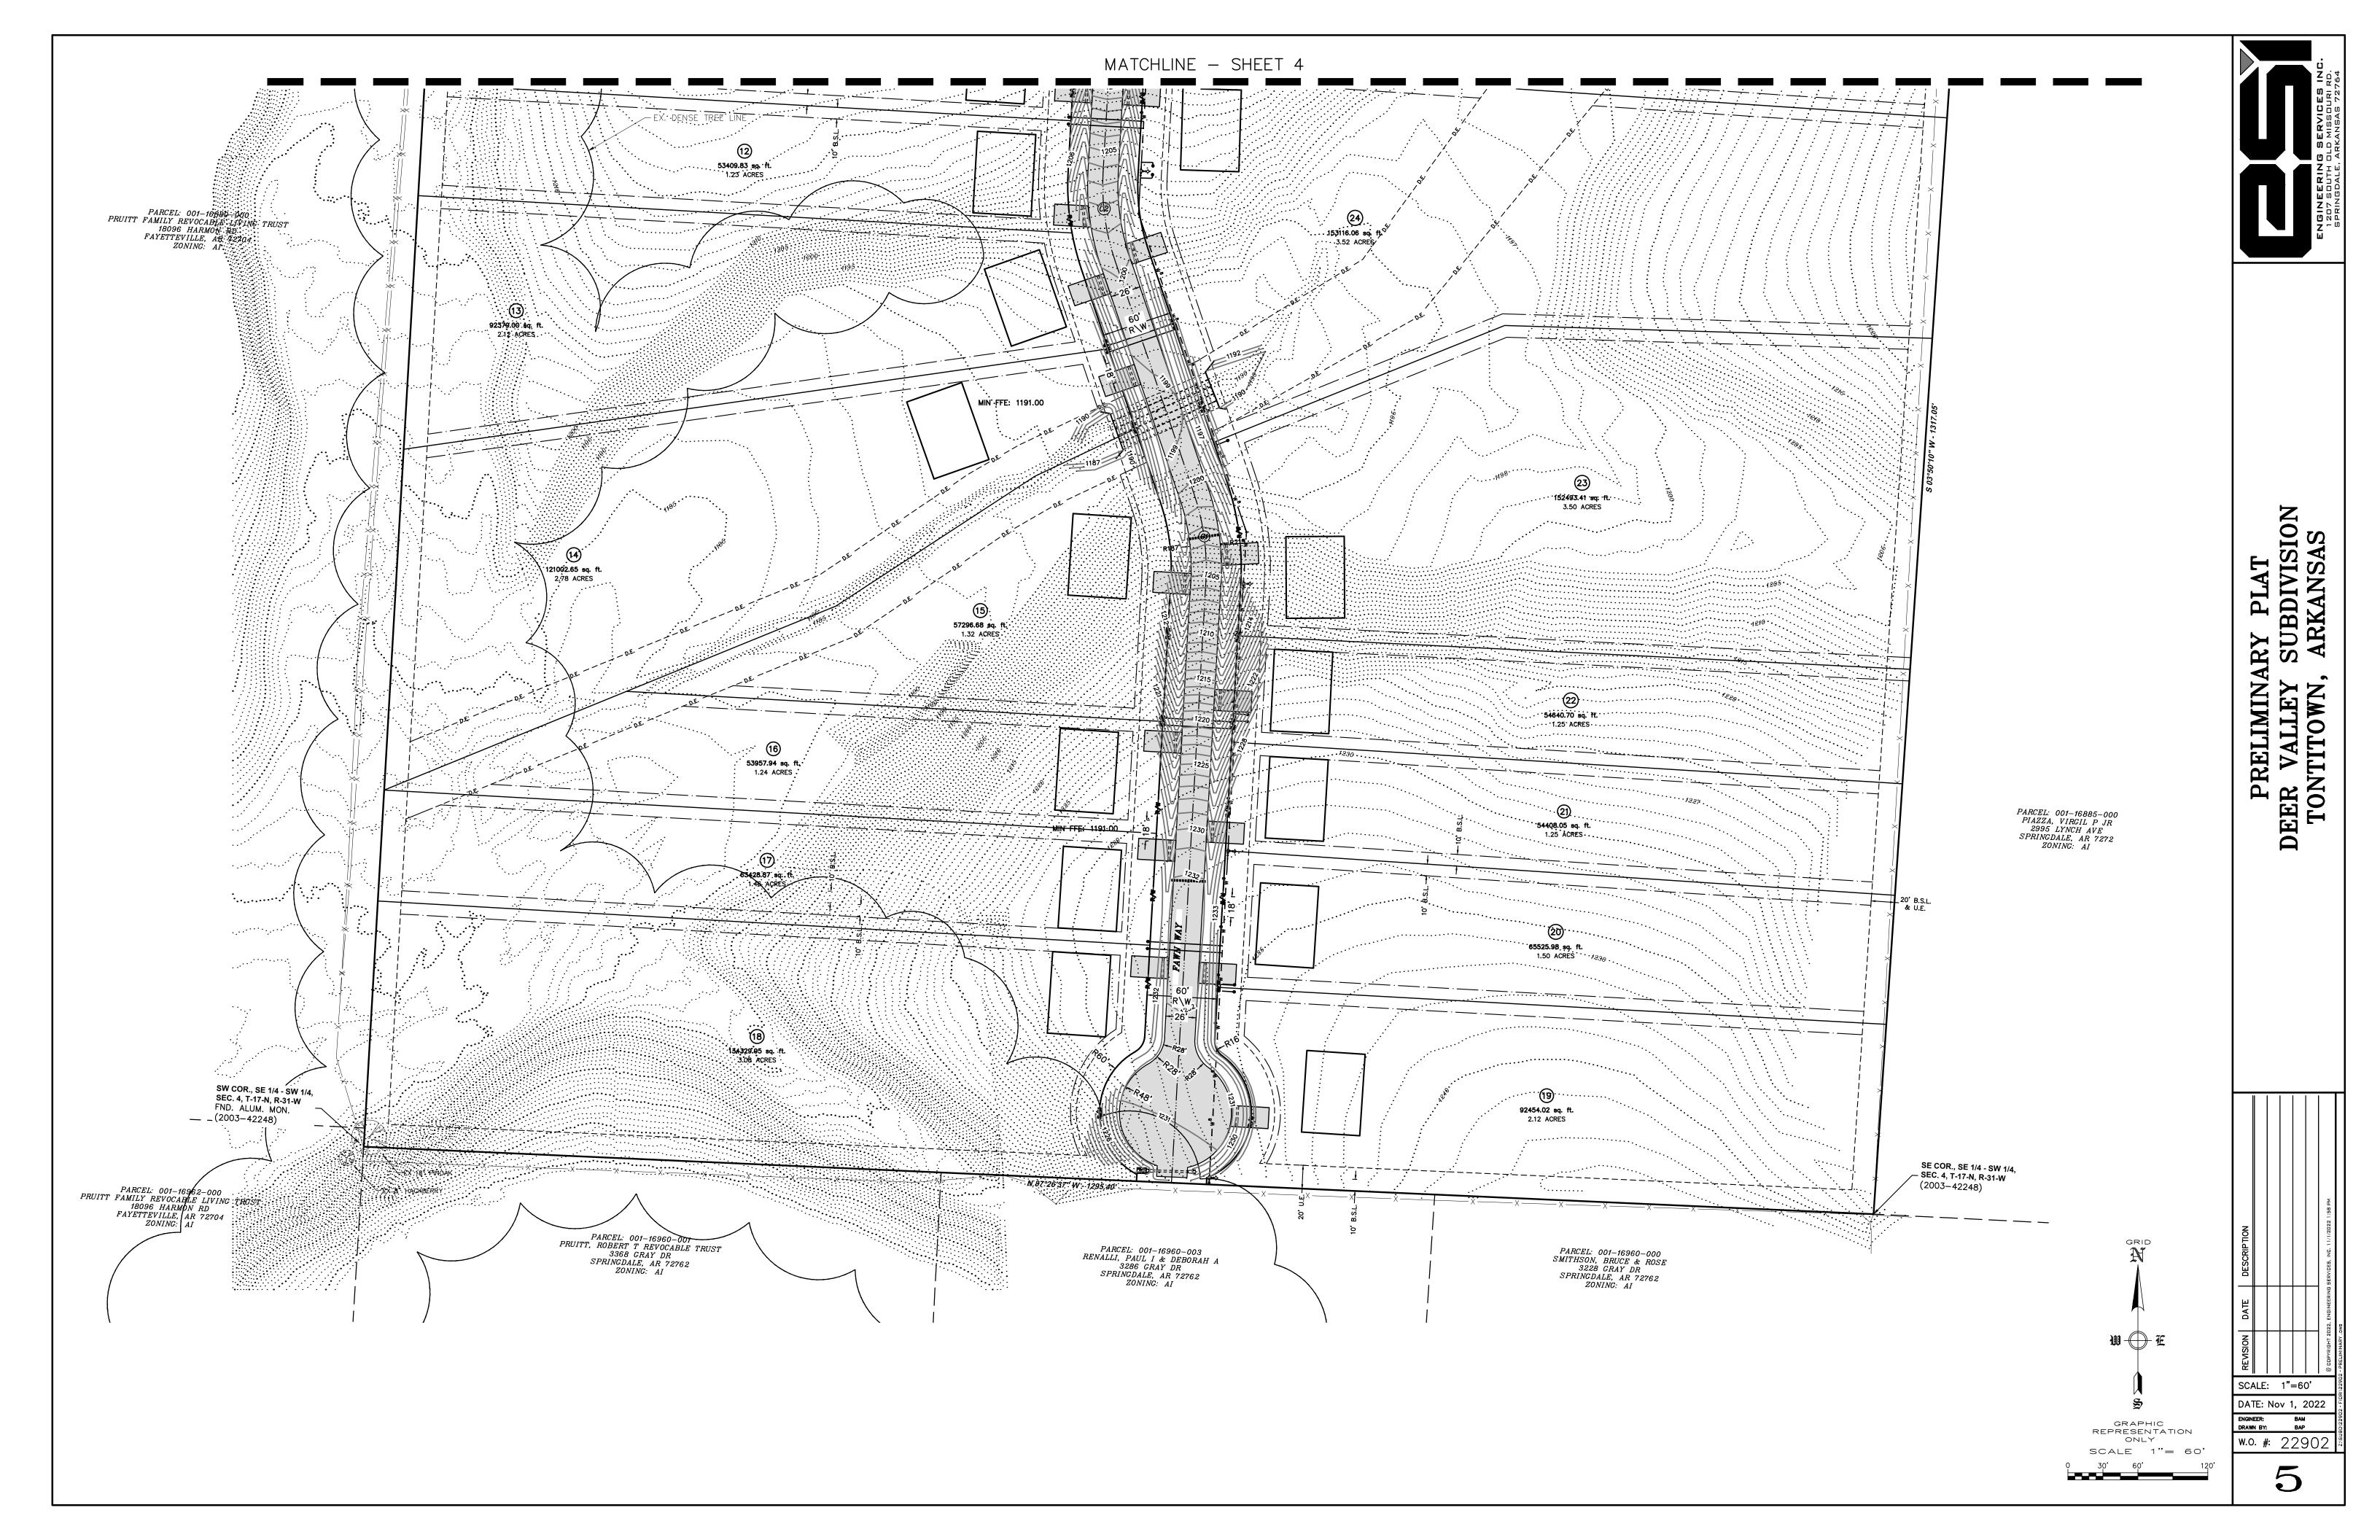
STREET PLAN DEER VALLEY TONTITOWN,

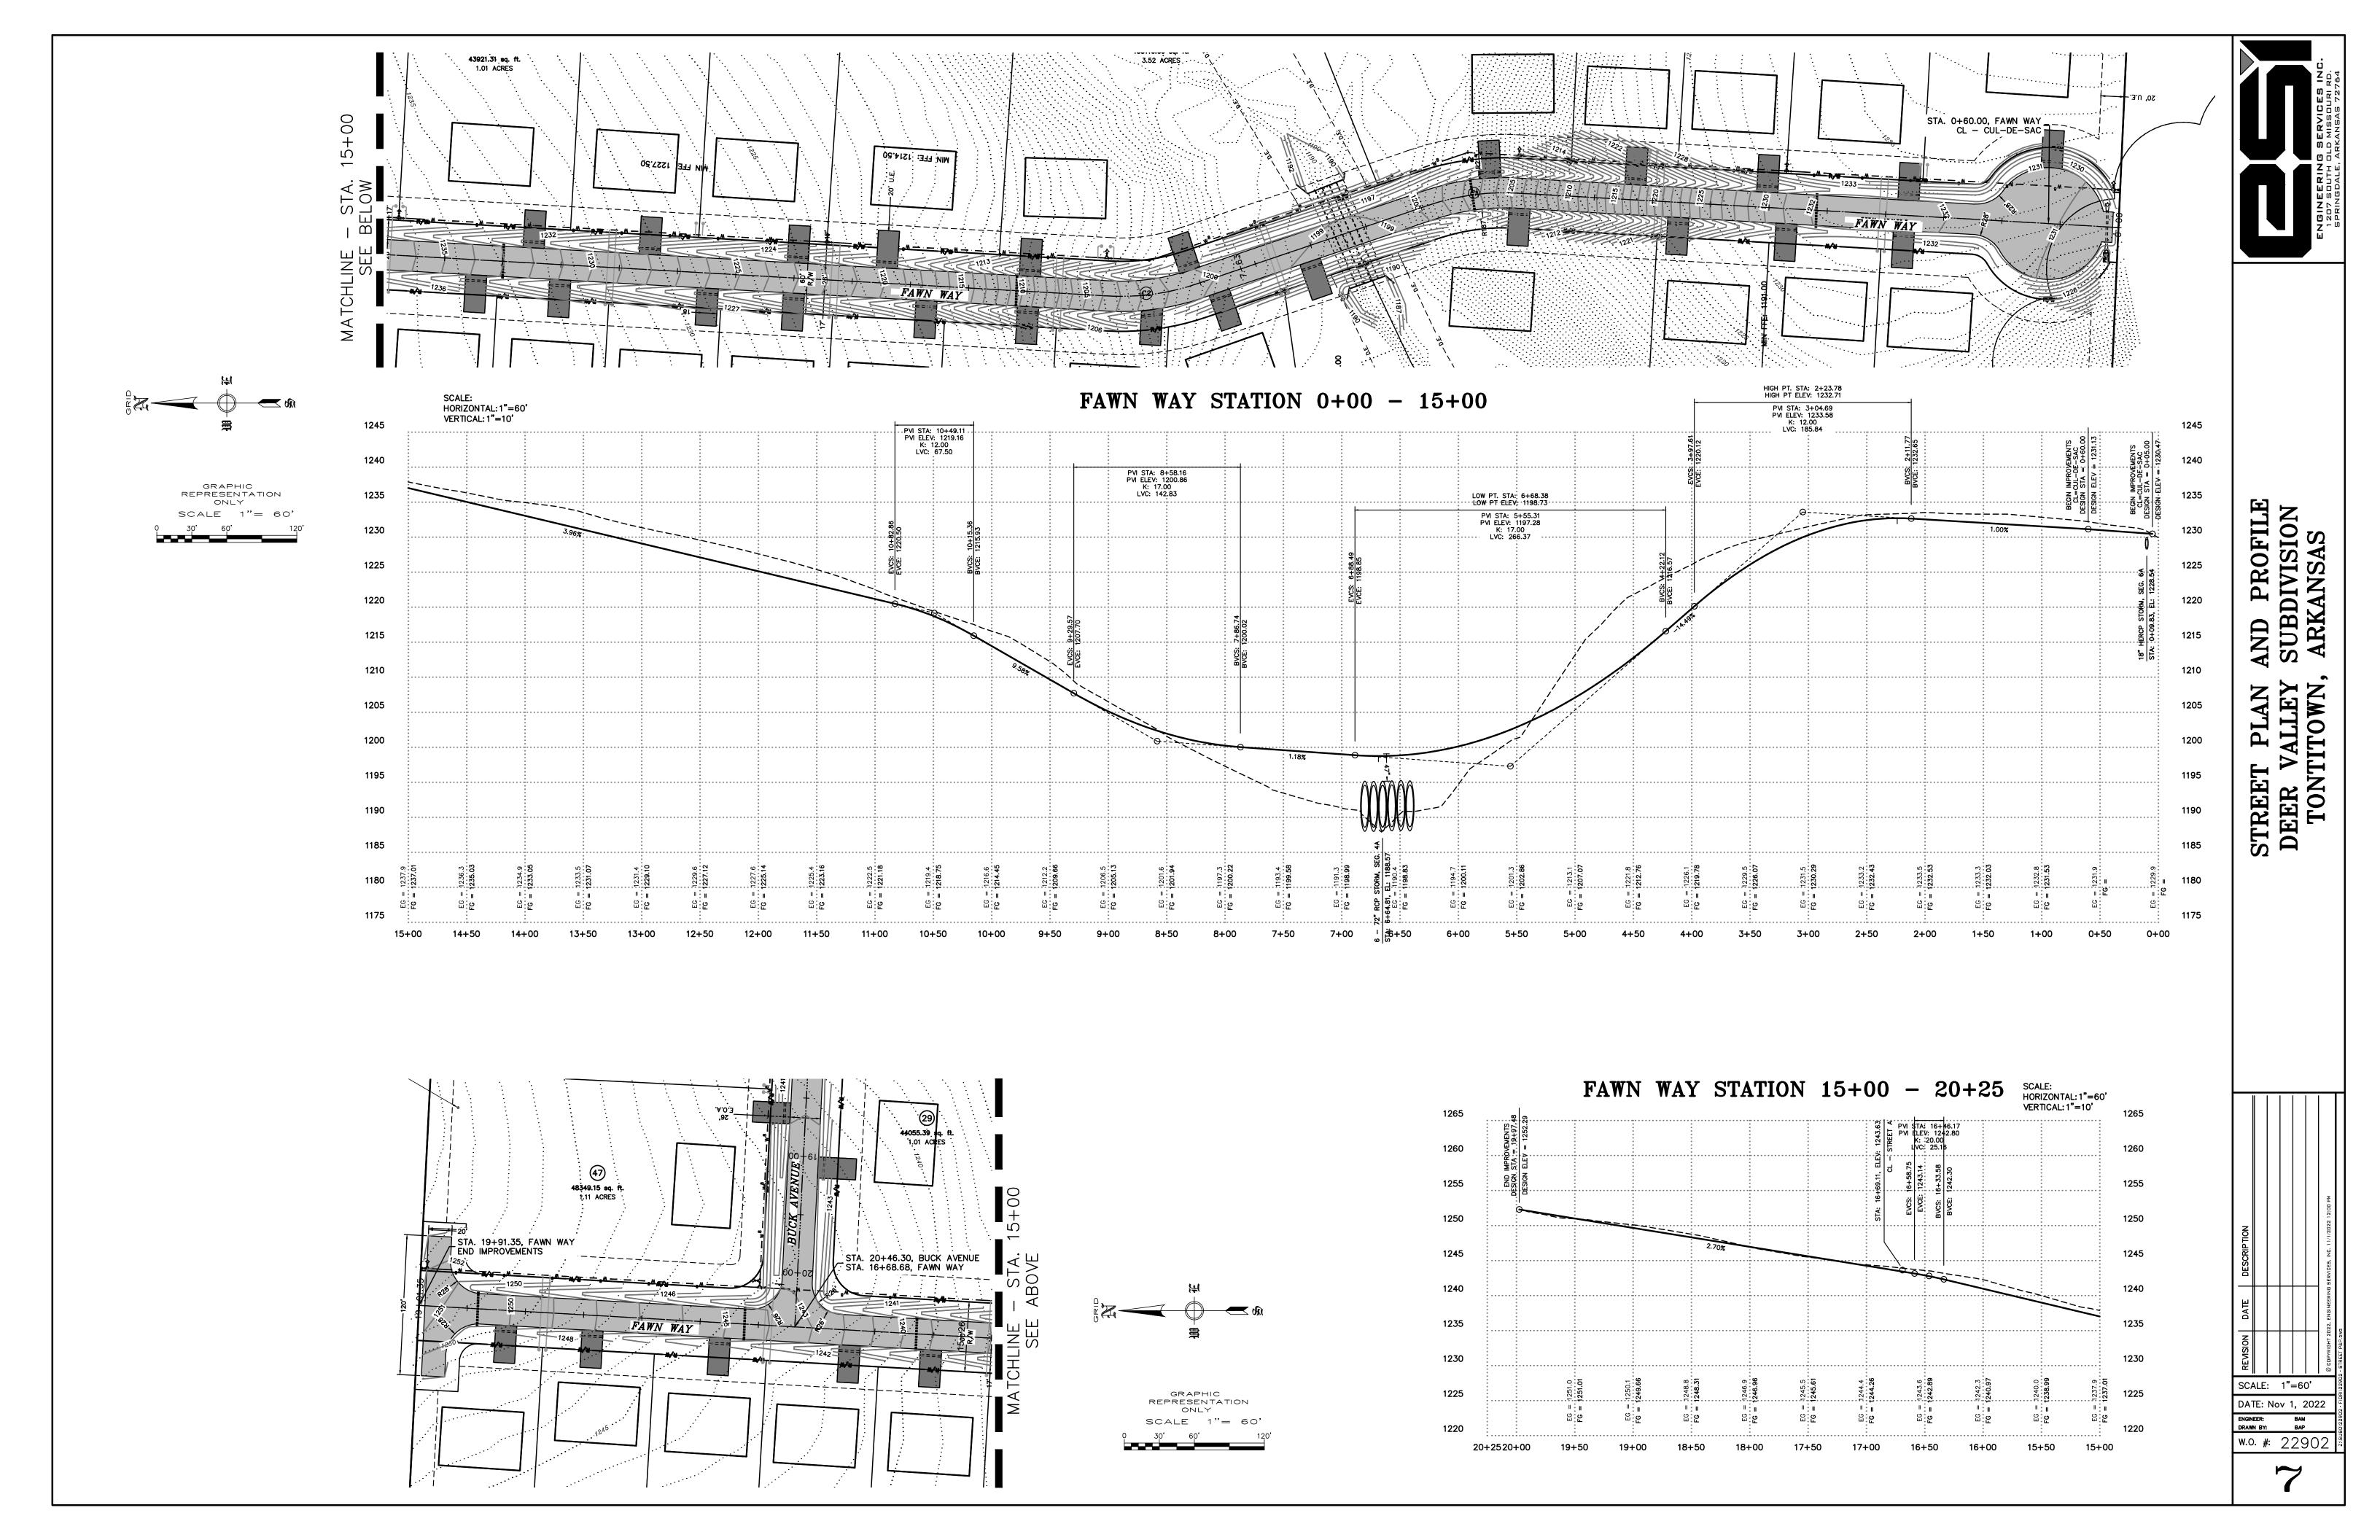

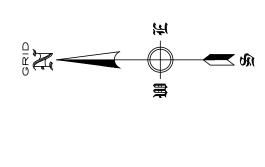

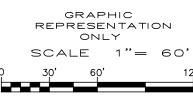

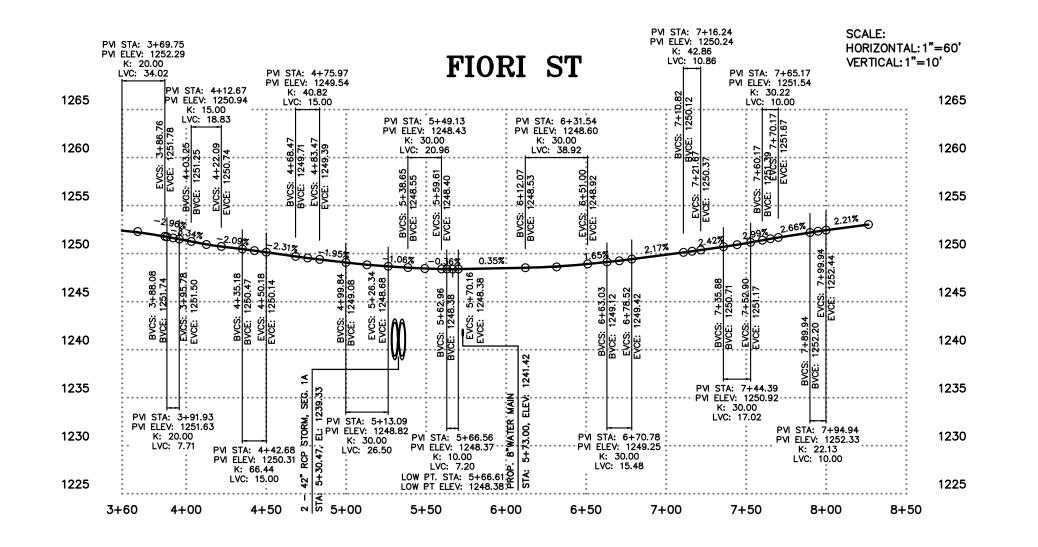


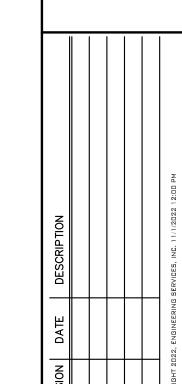


SCALE: 1"=60' DATE: Nov 1, 2022

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w.o. #: 22902




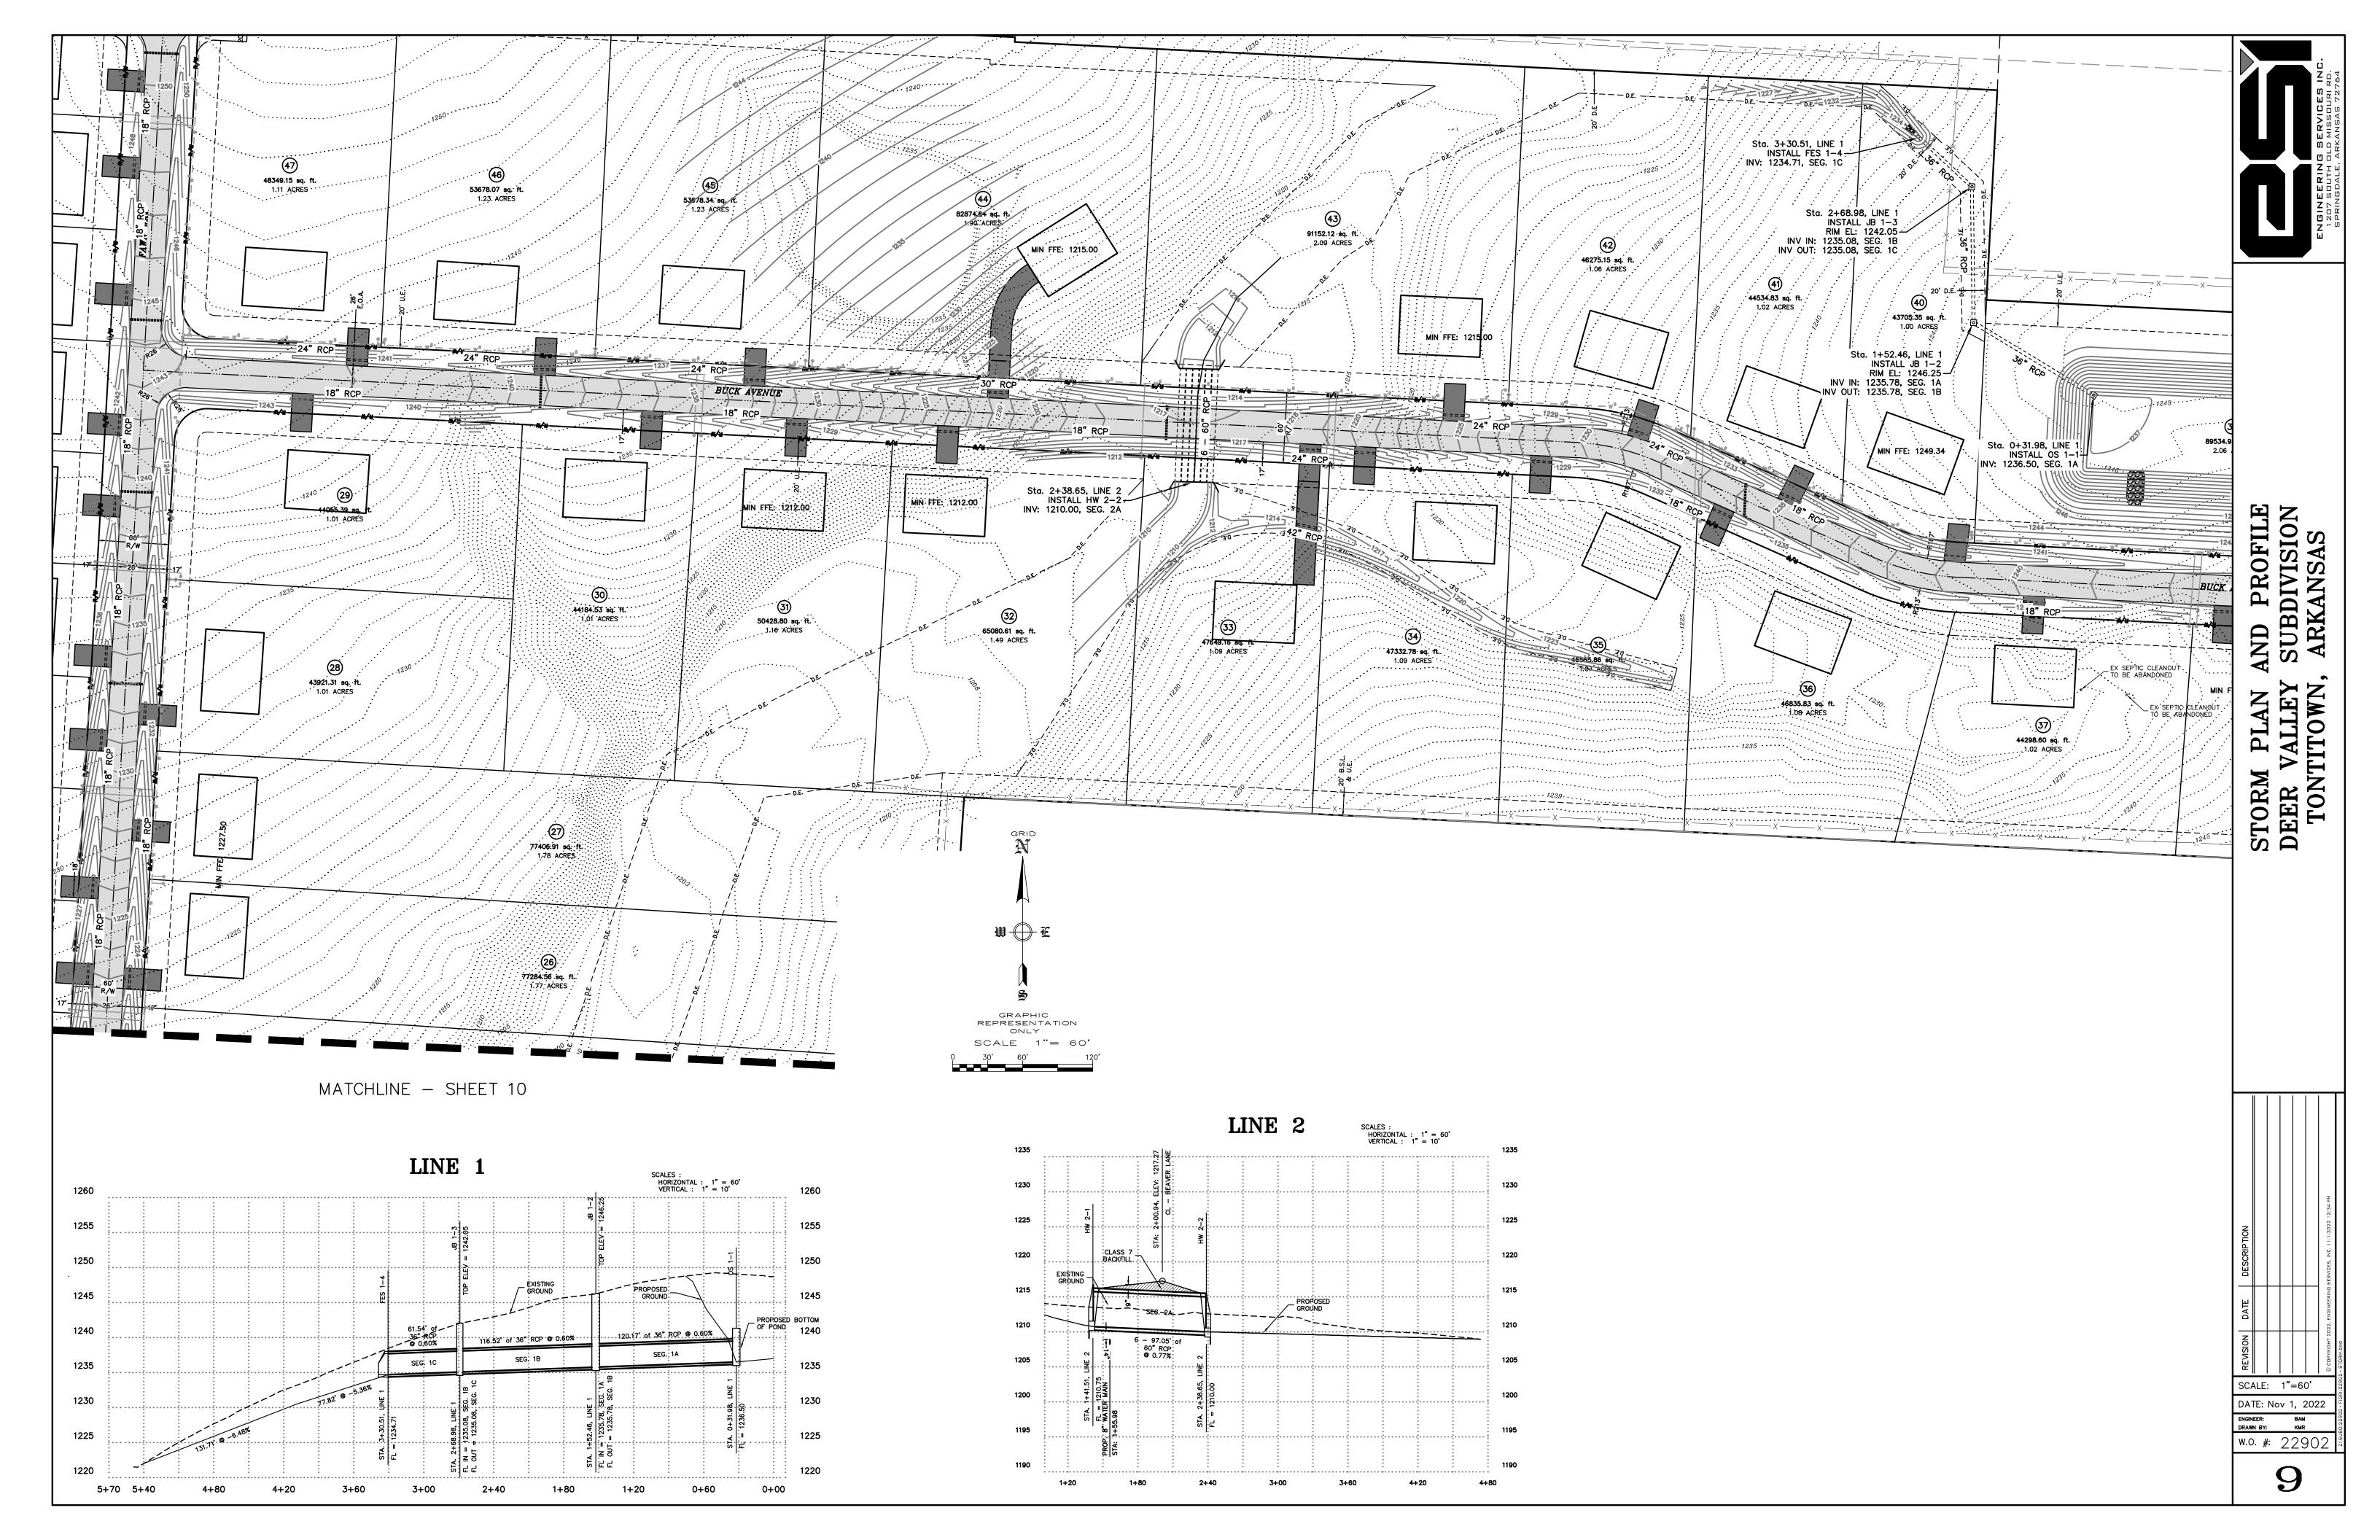


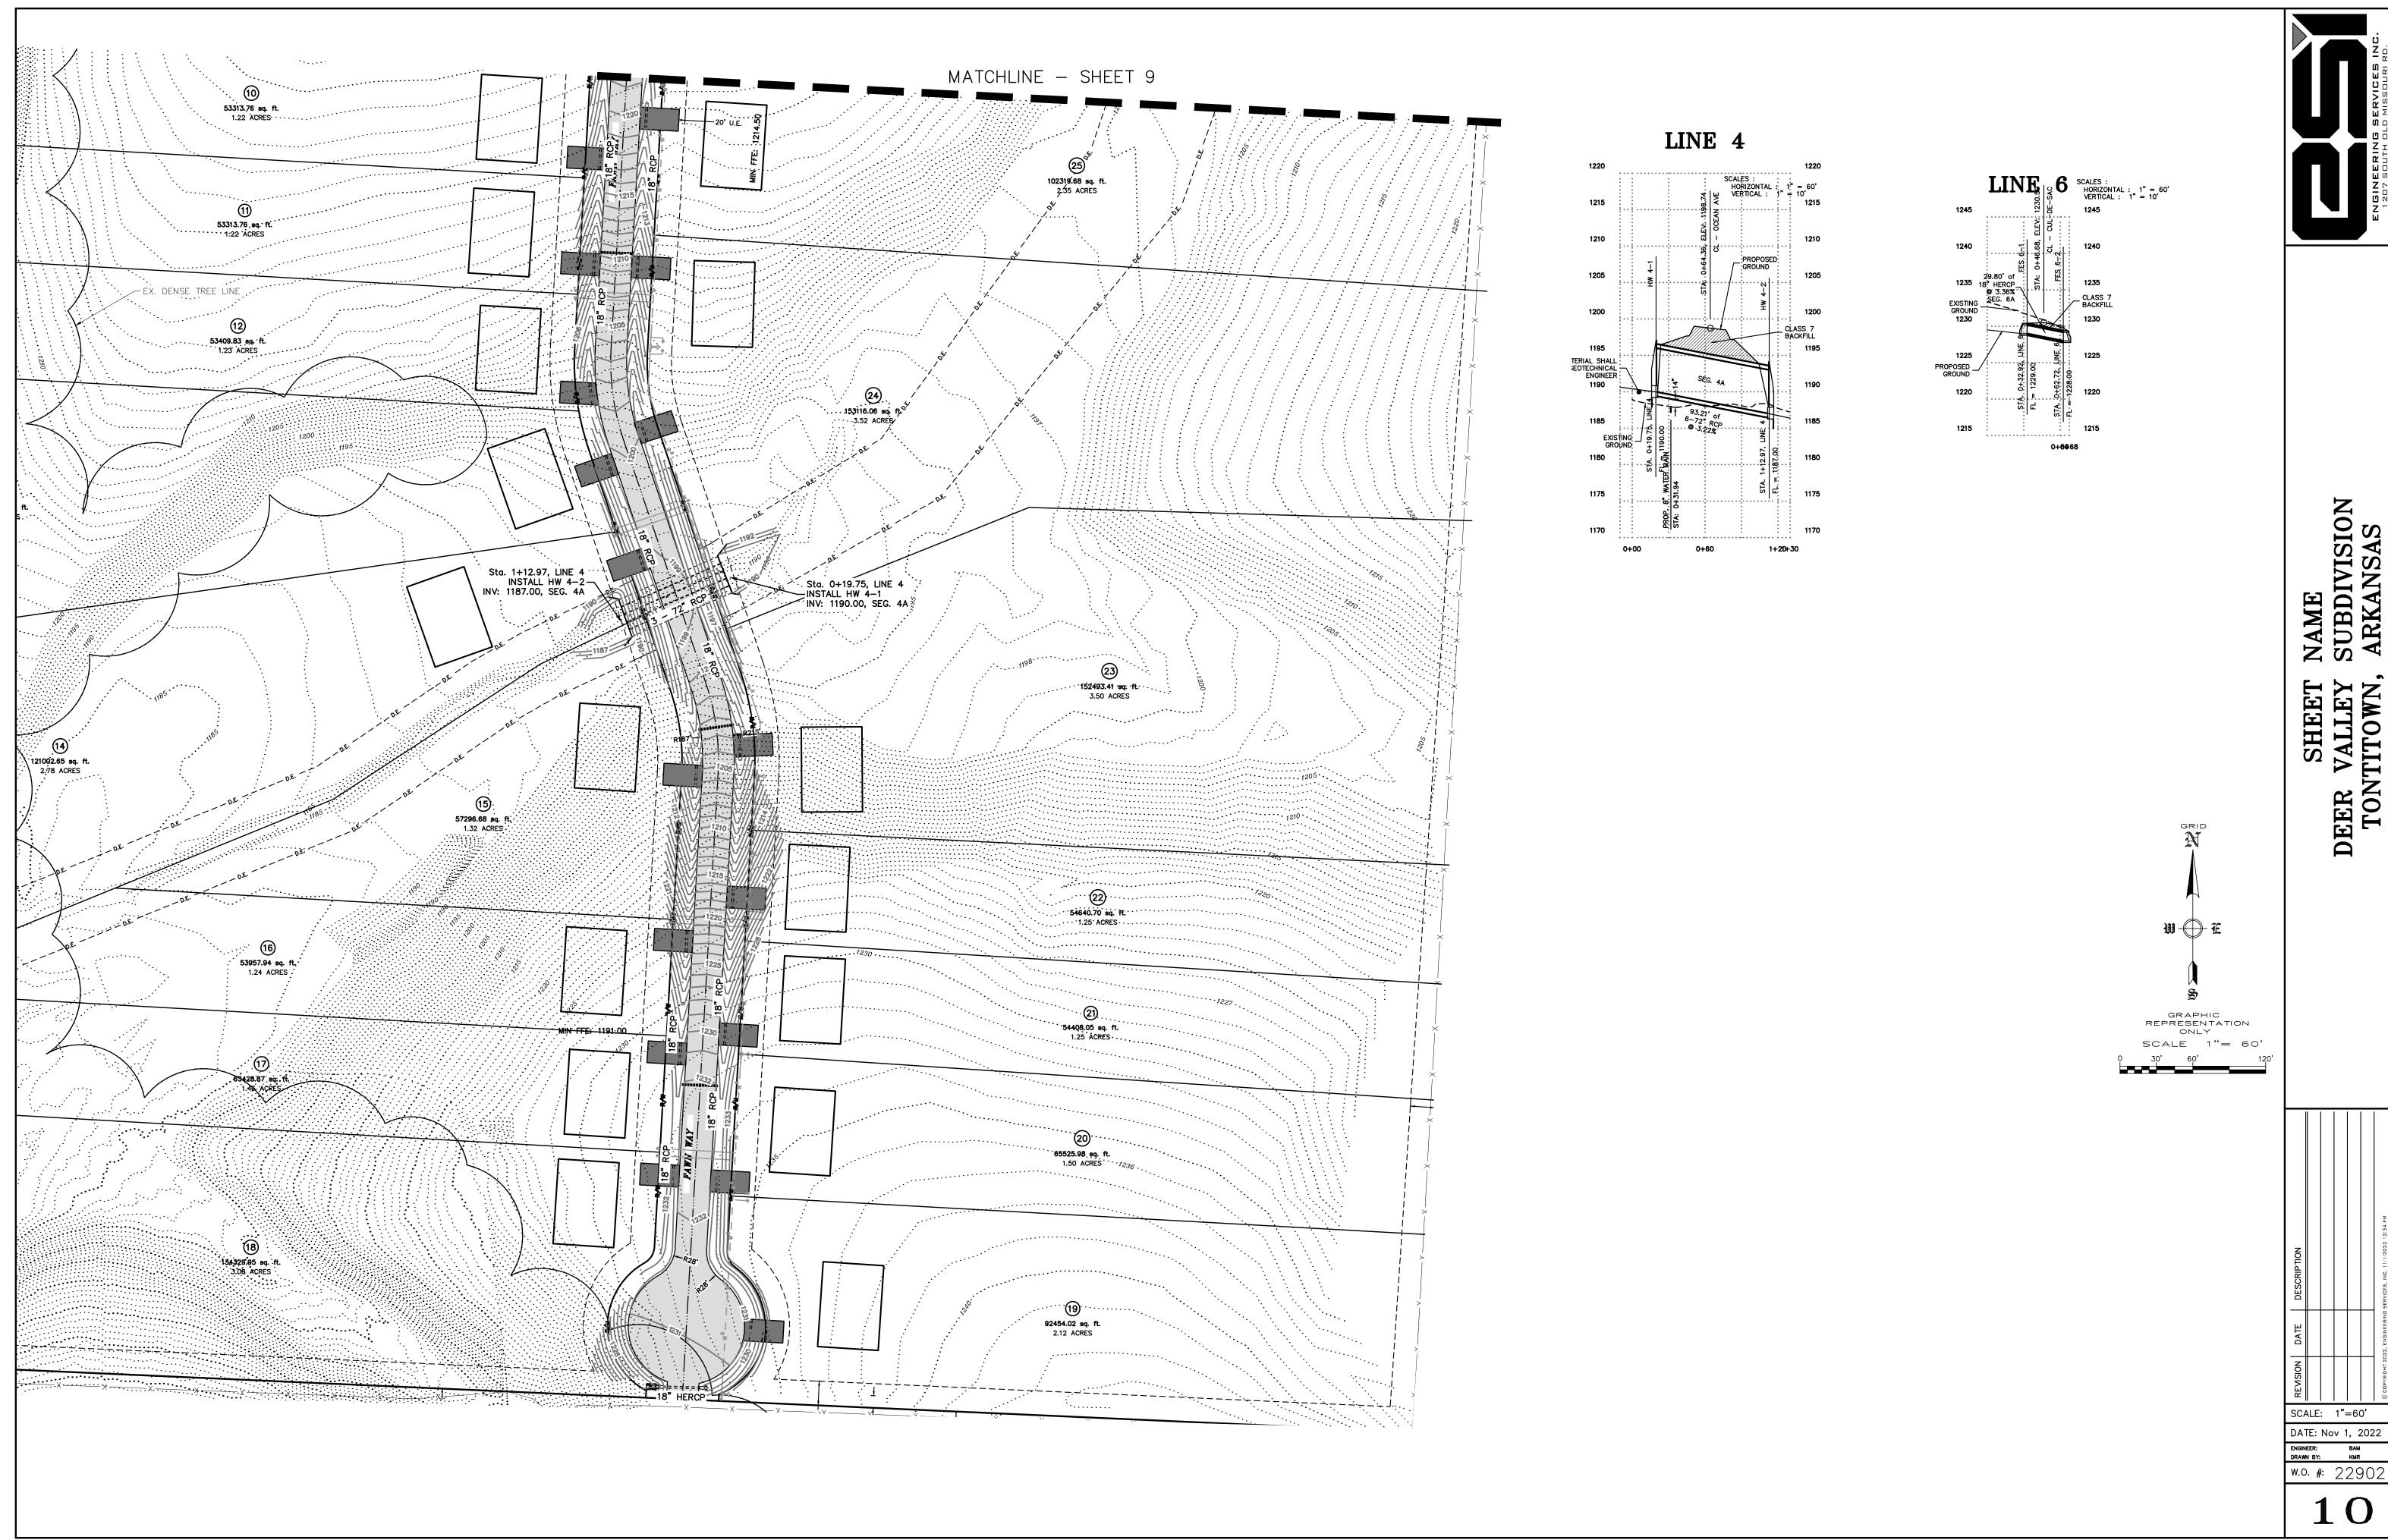



NAME SUBDIVISION ARKANSAS SHEET
DEER VALLEY
TONTITOWN,


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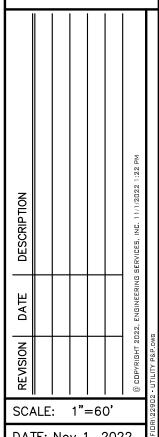


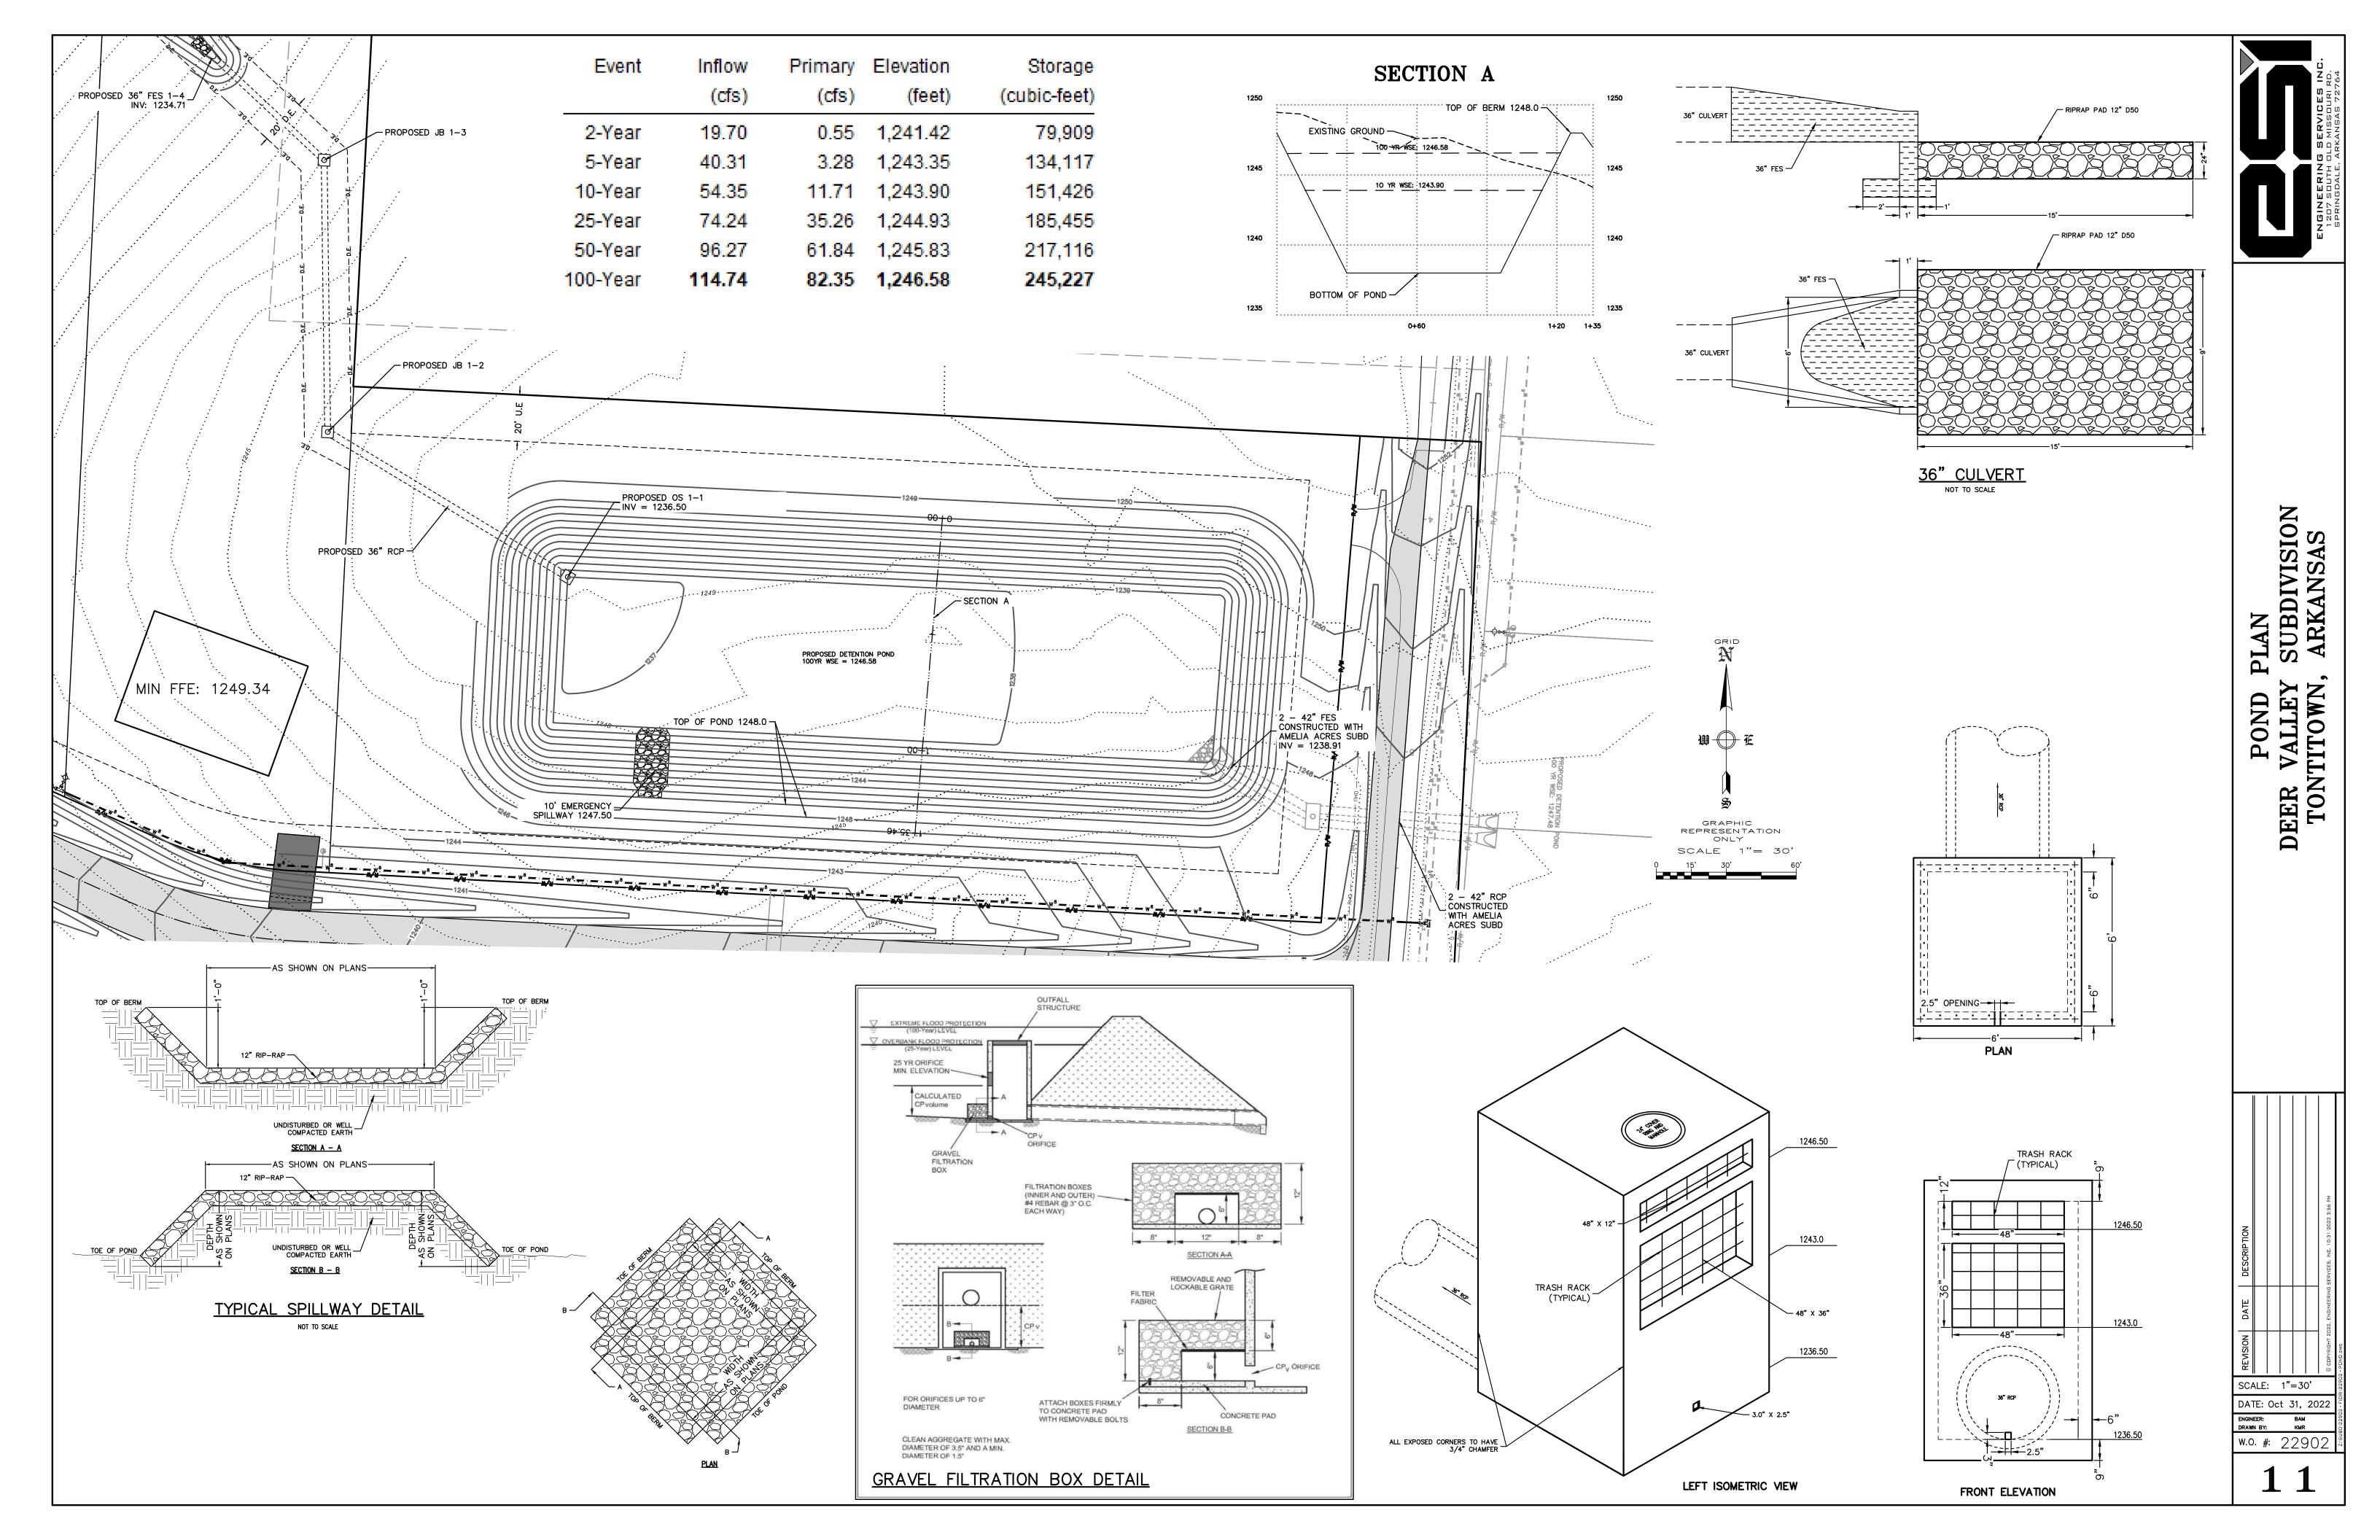


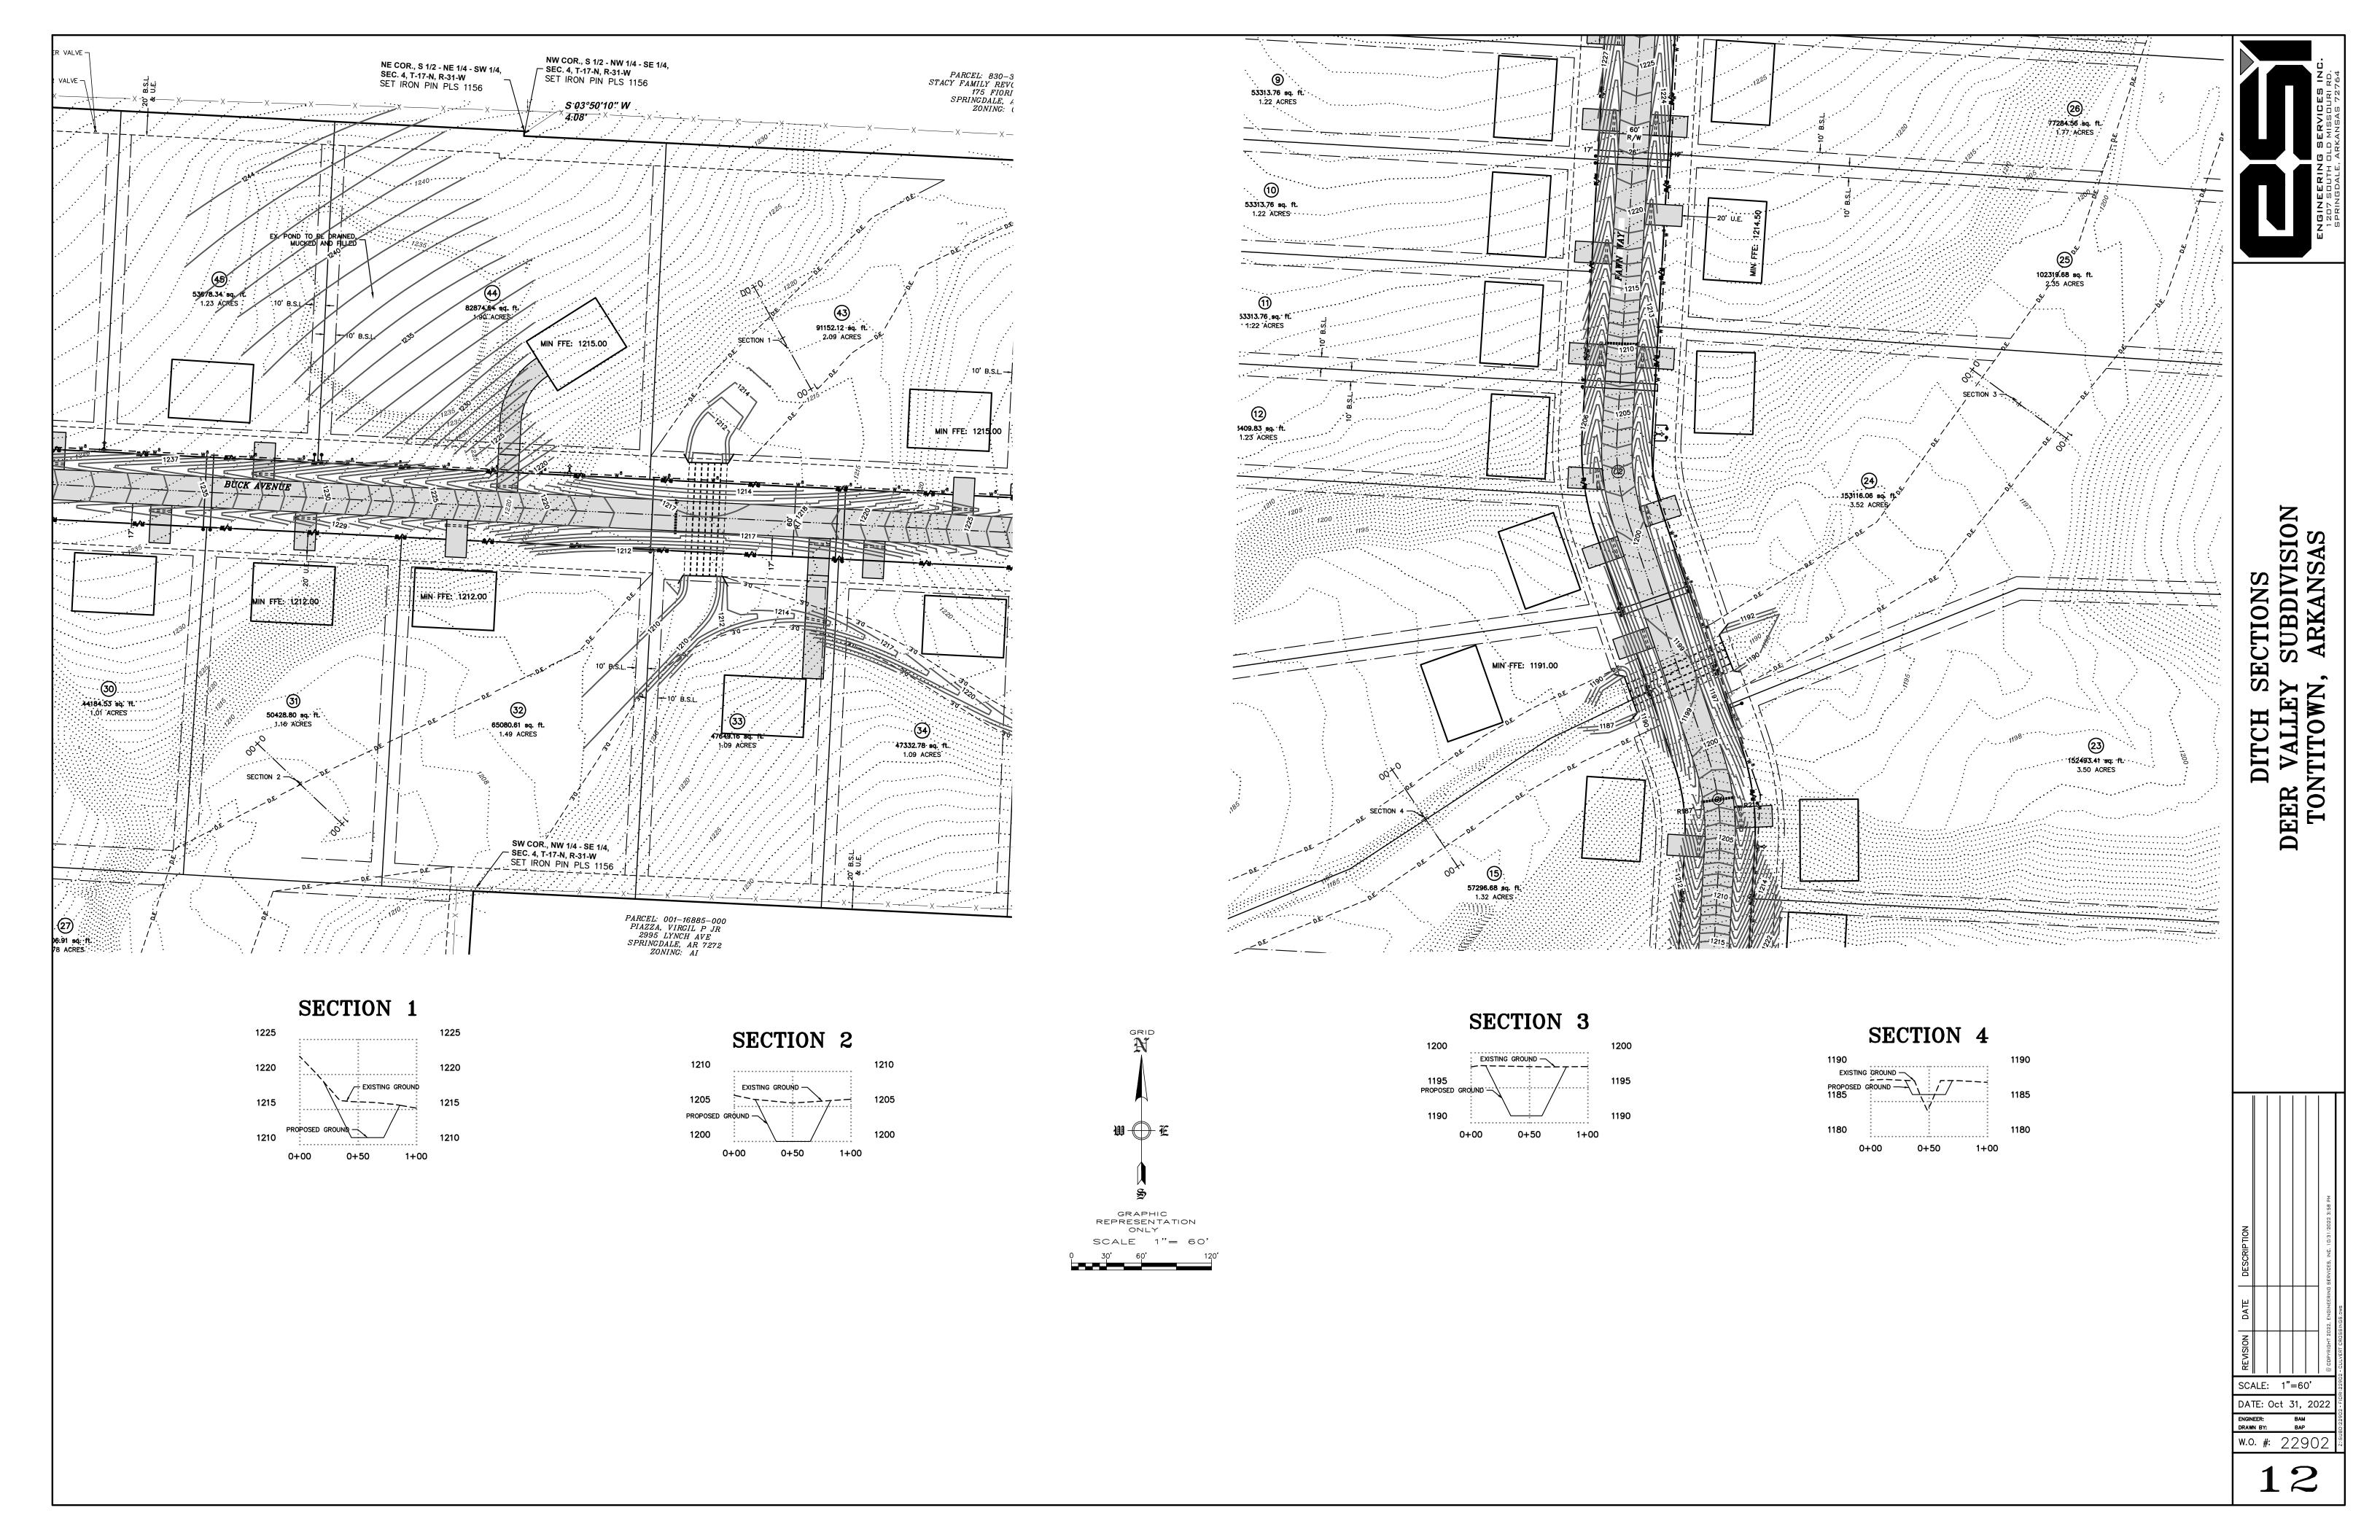

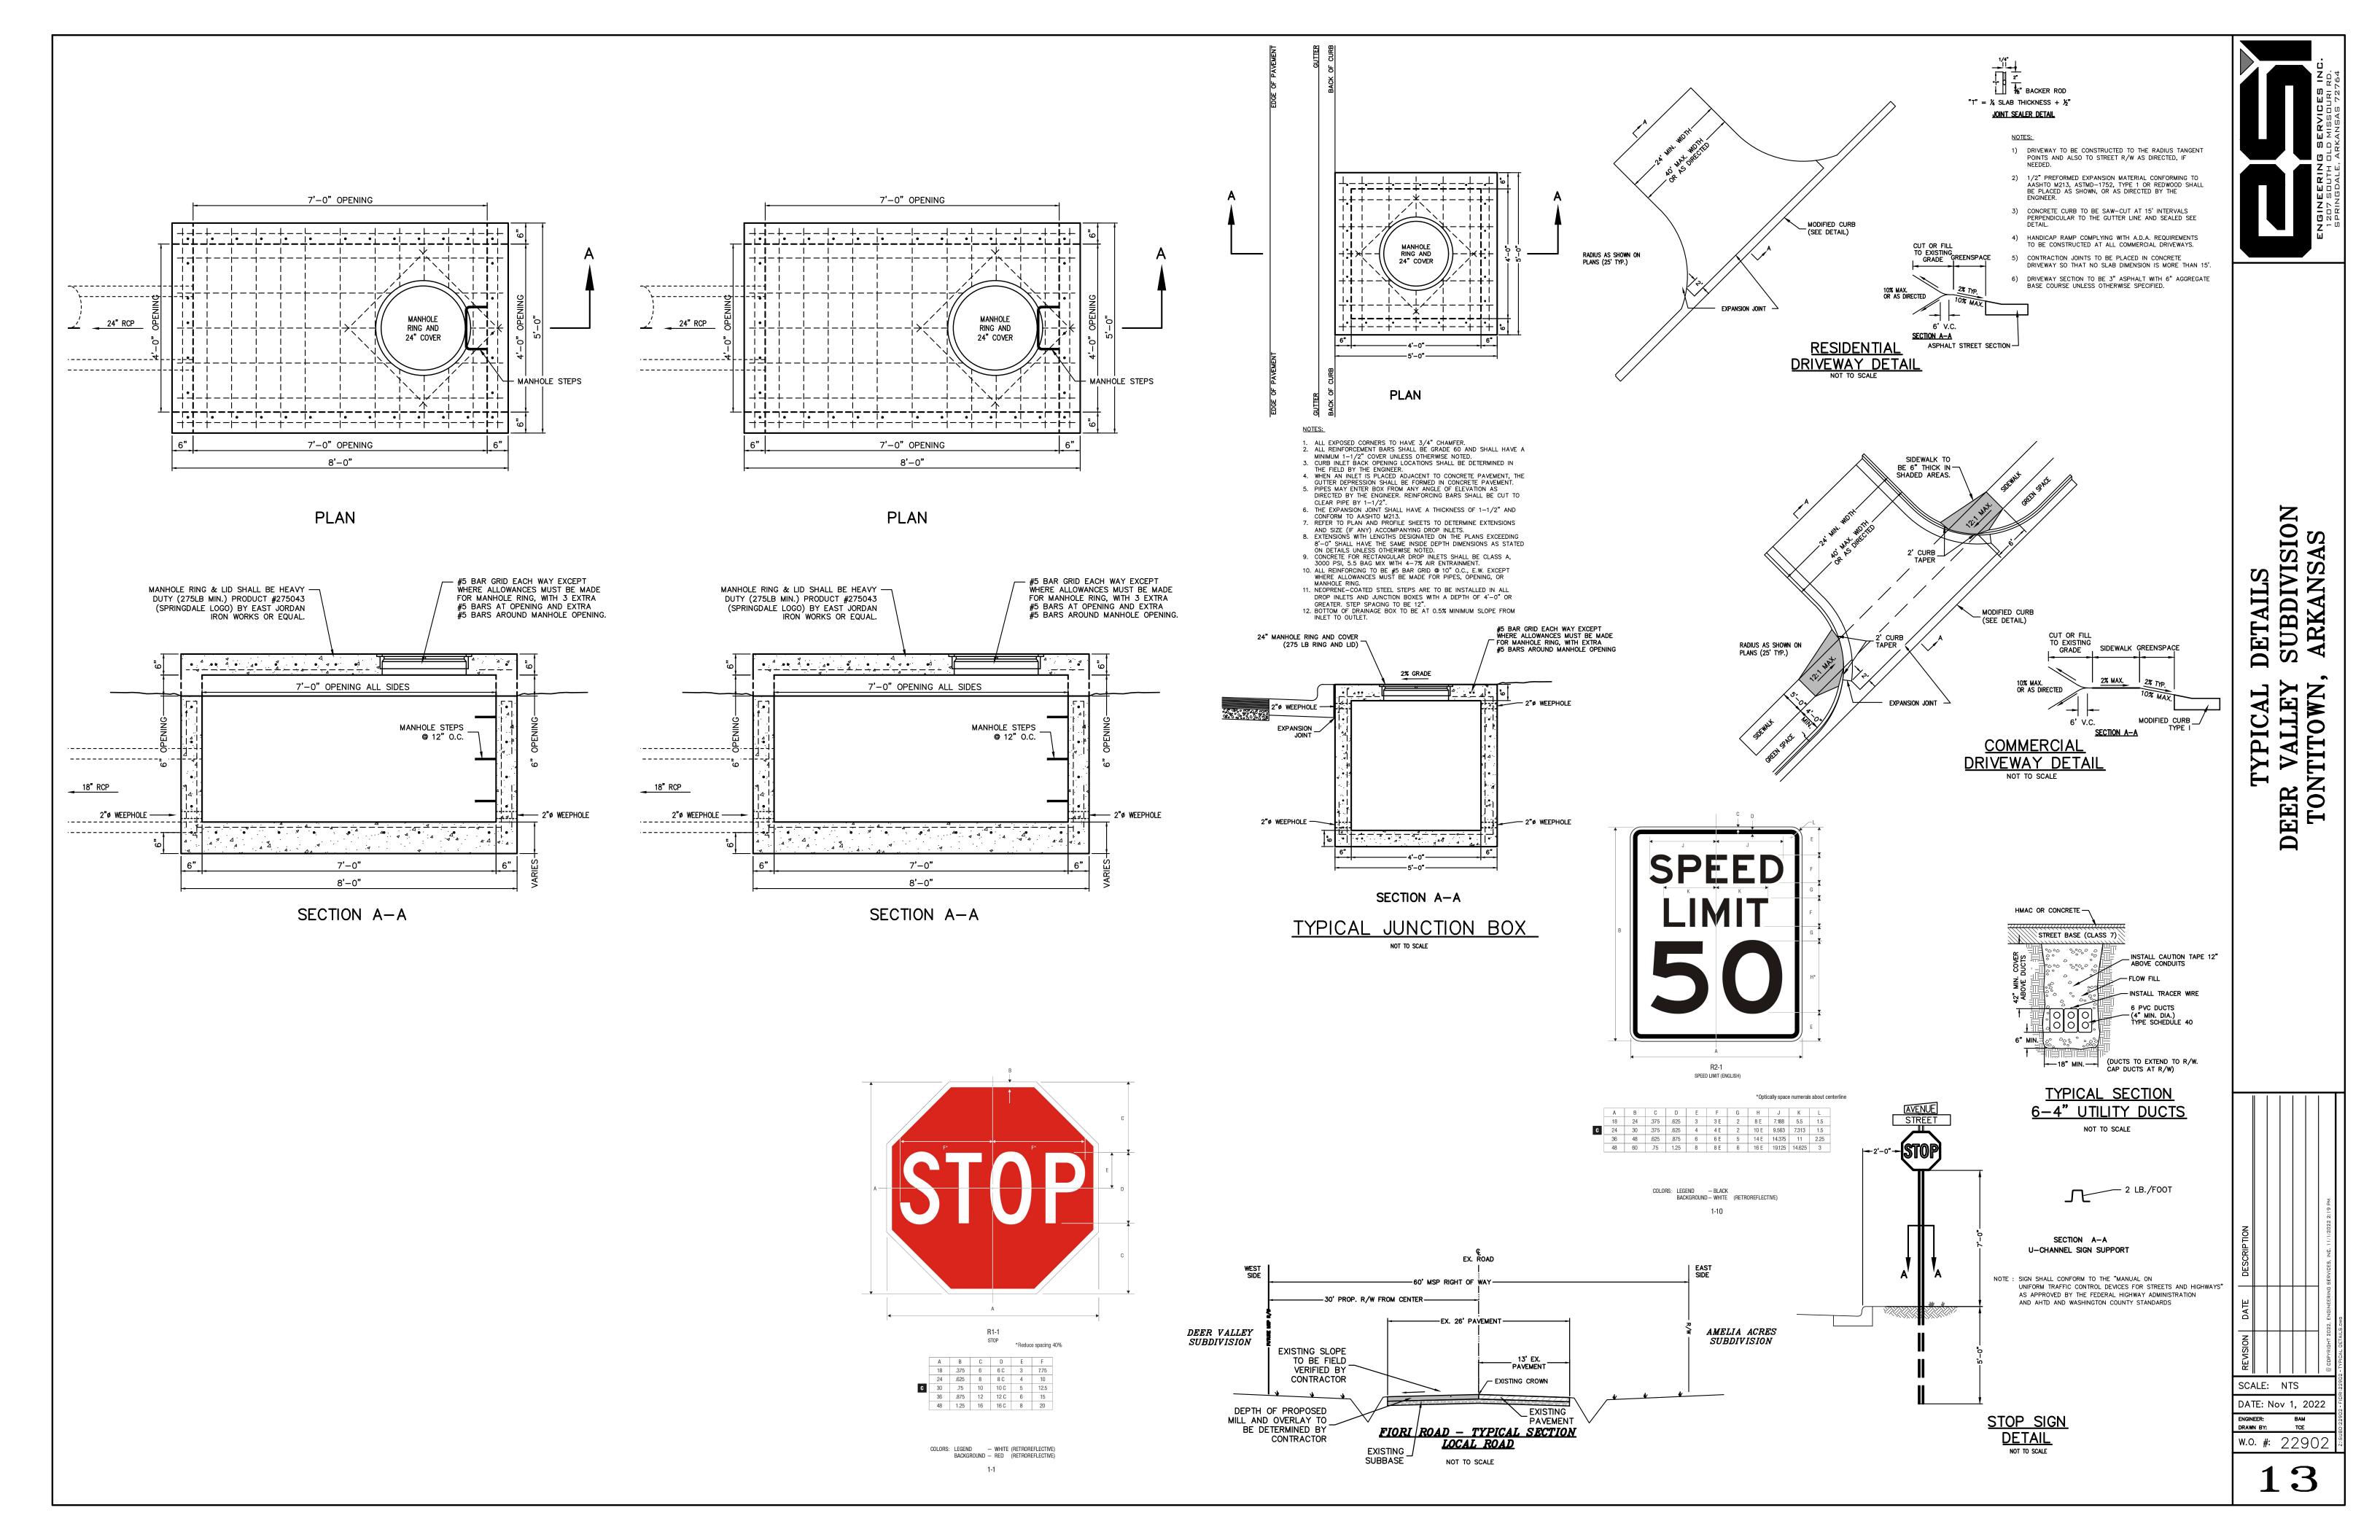

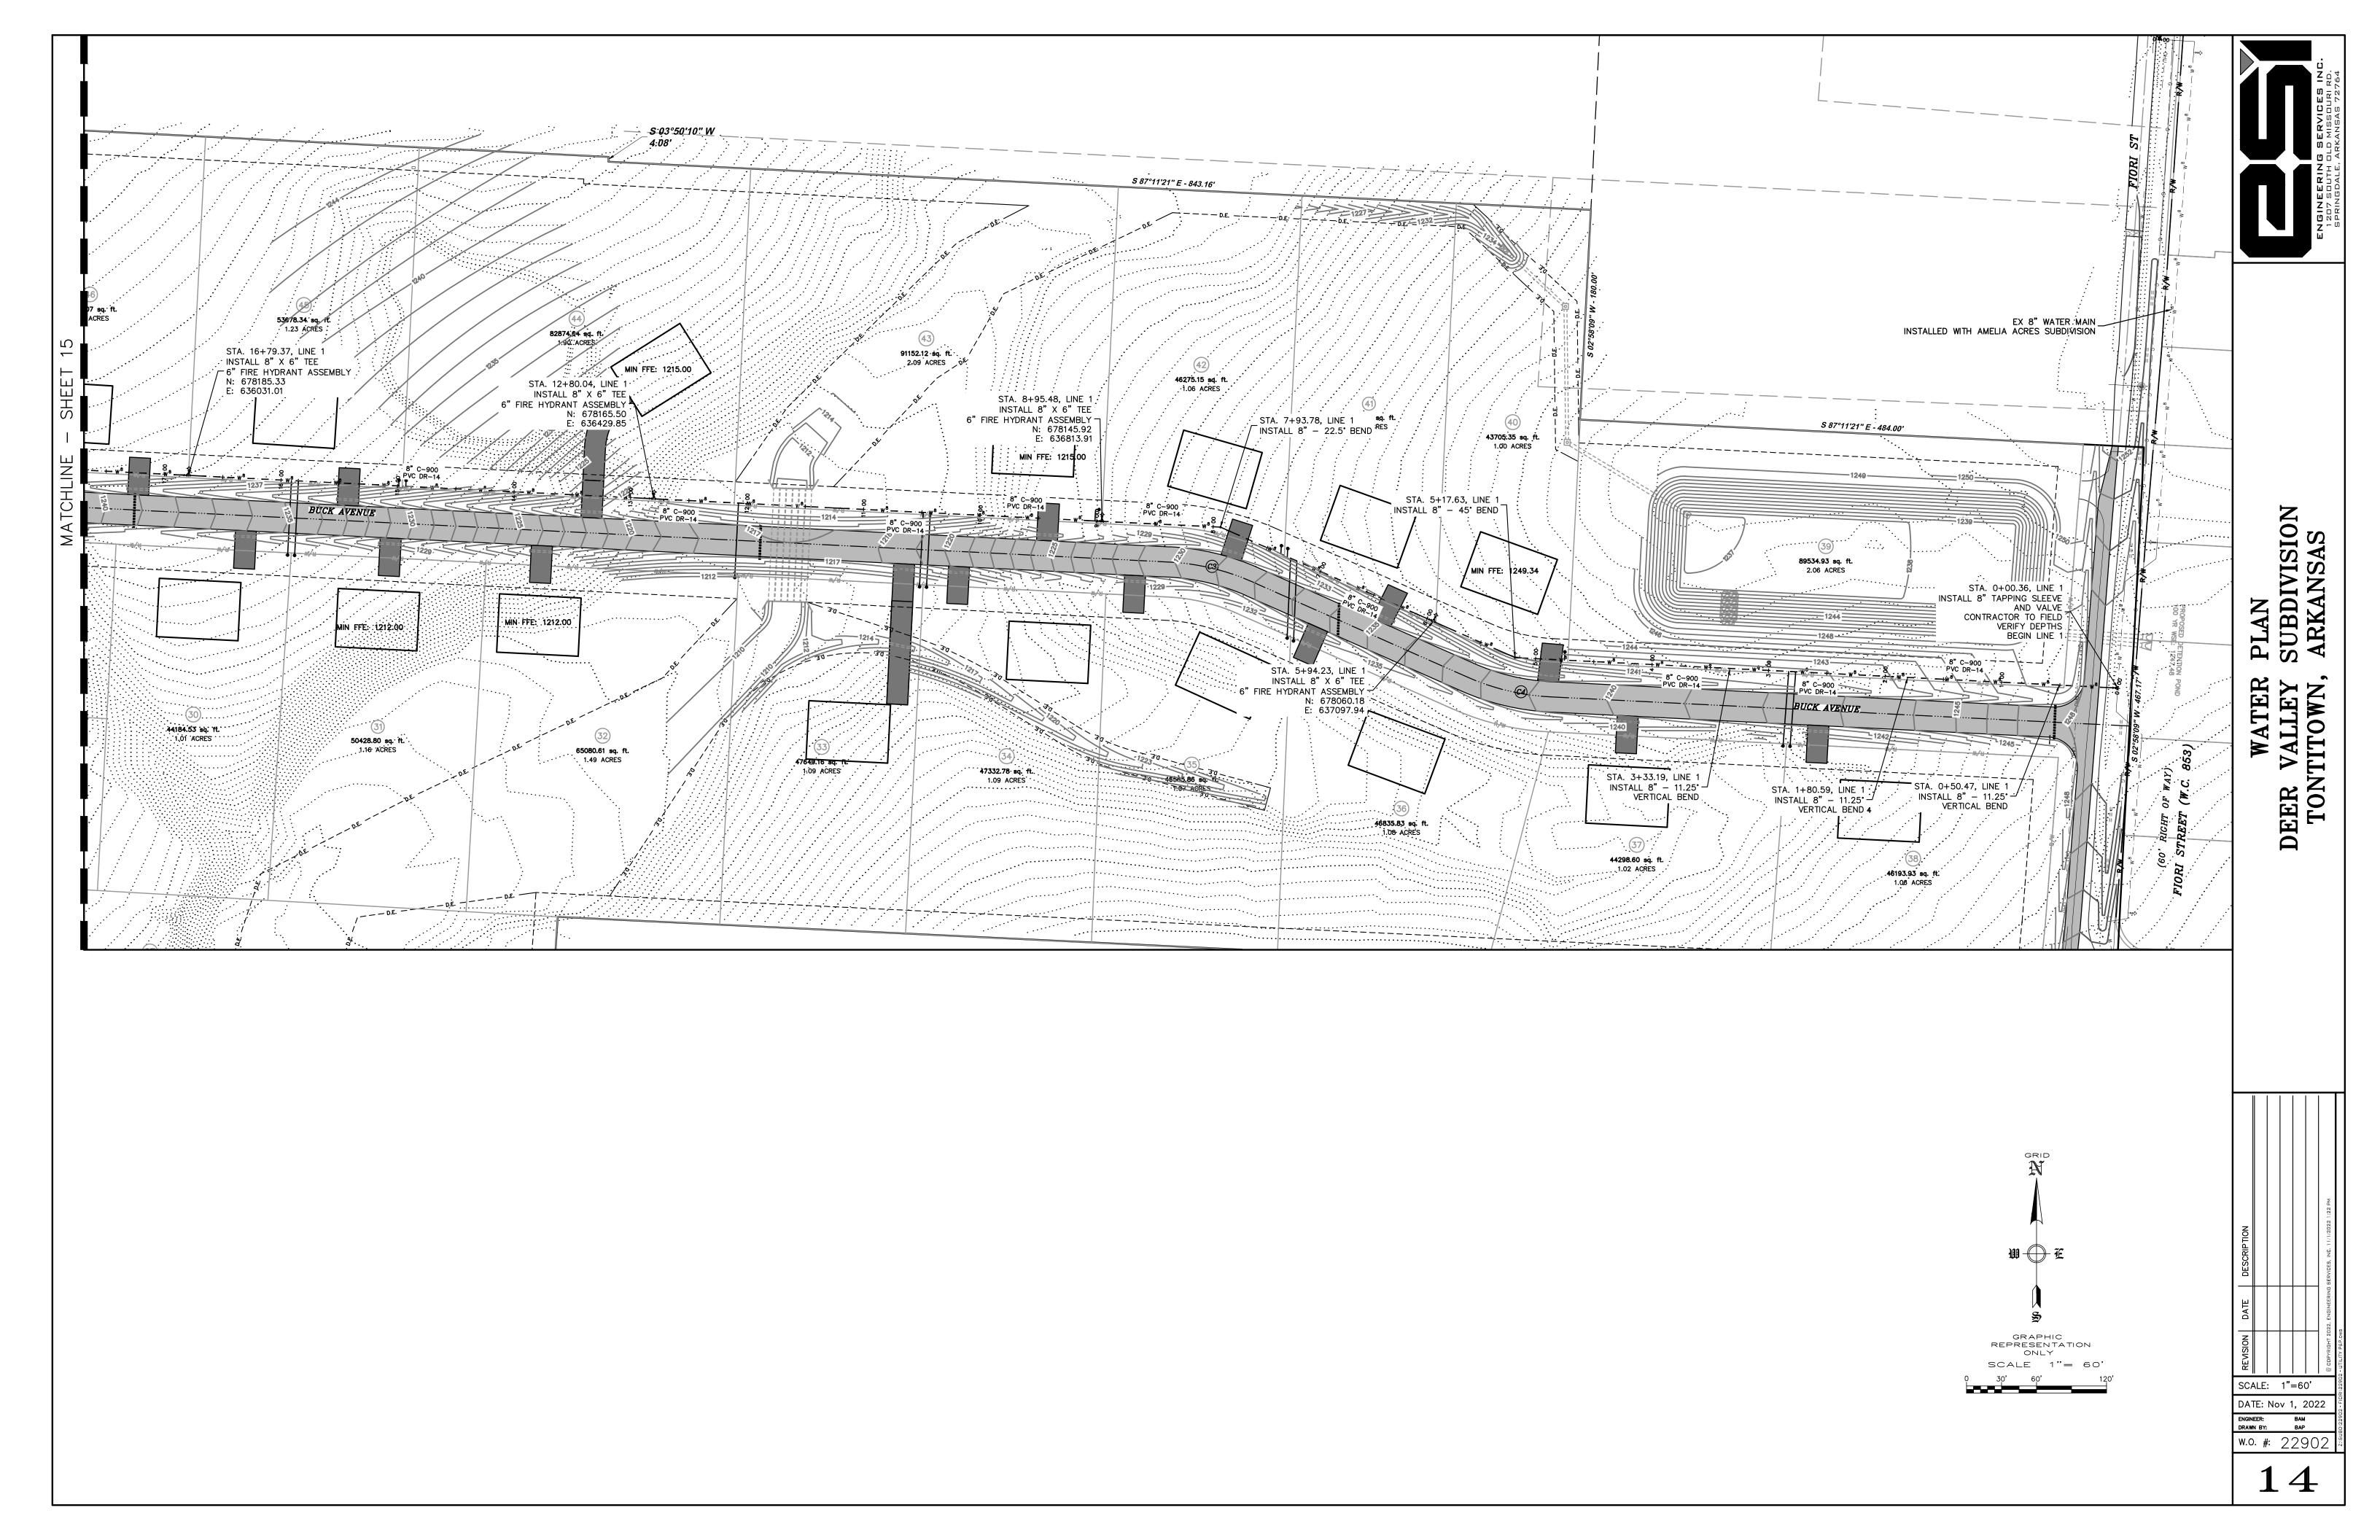
PLAN SUBDIVISION ARKANSAS WATER DEER VALLEY TONTITOWN,

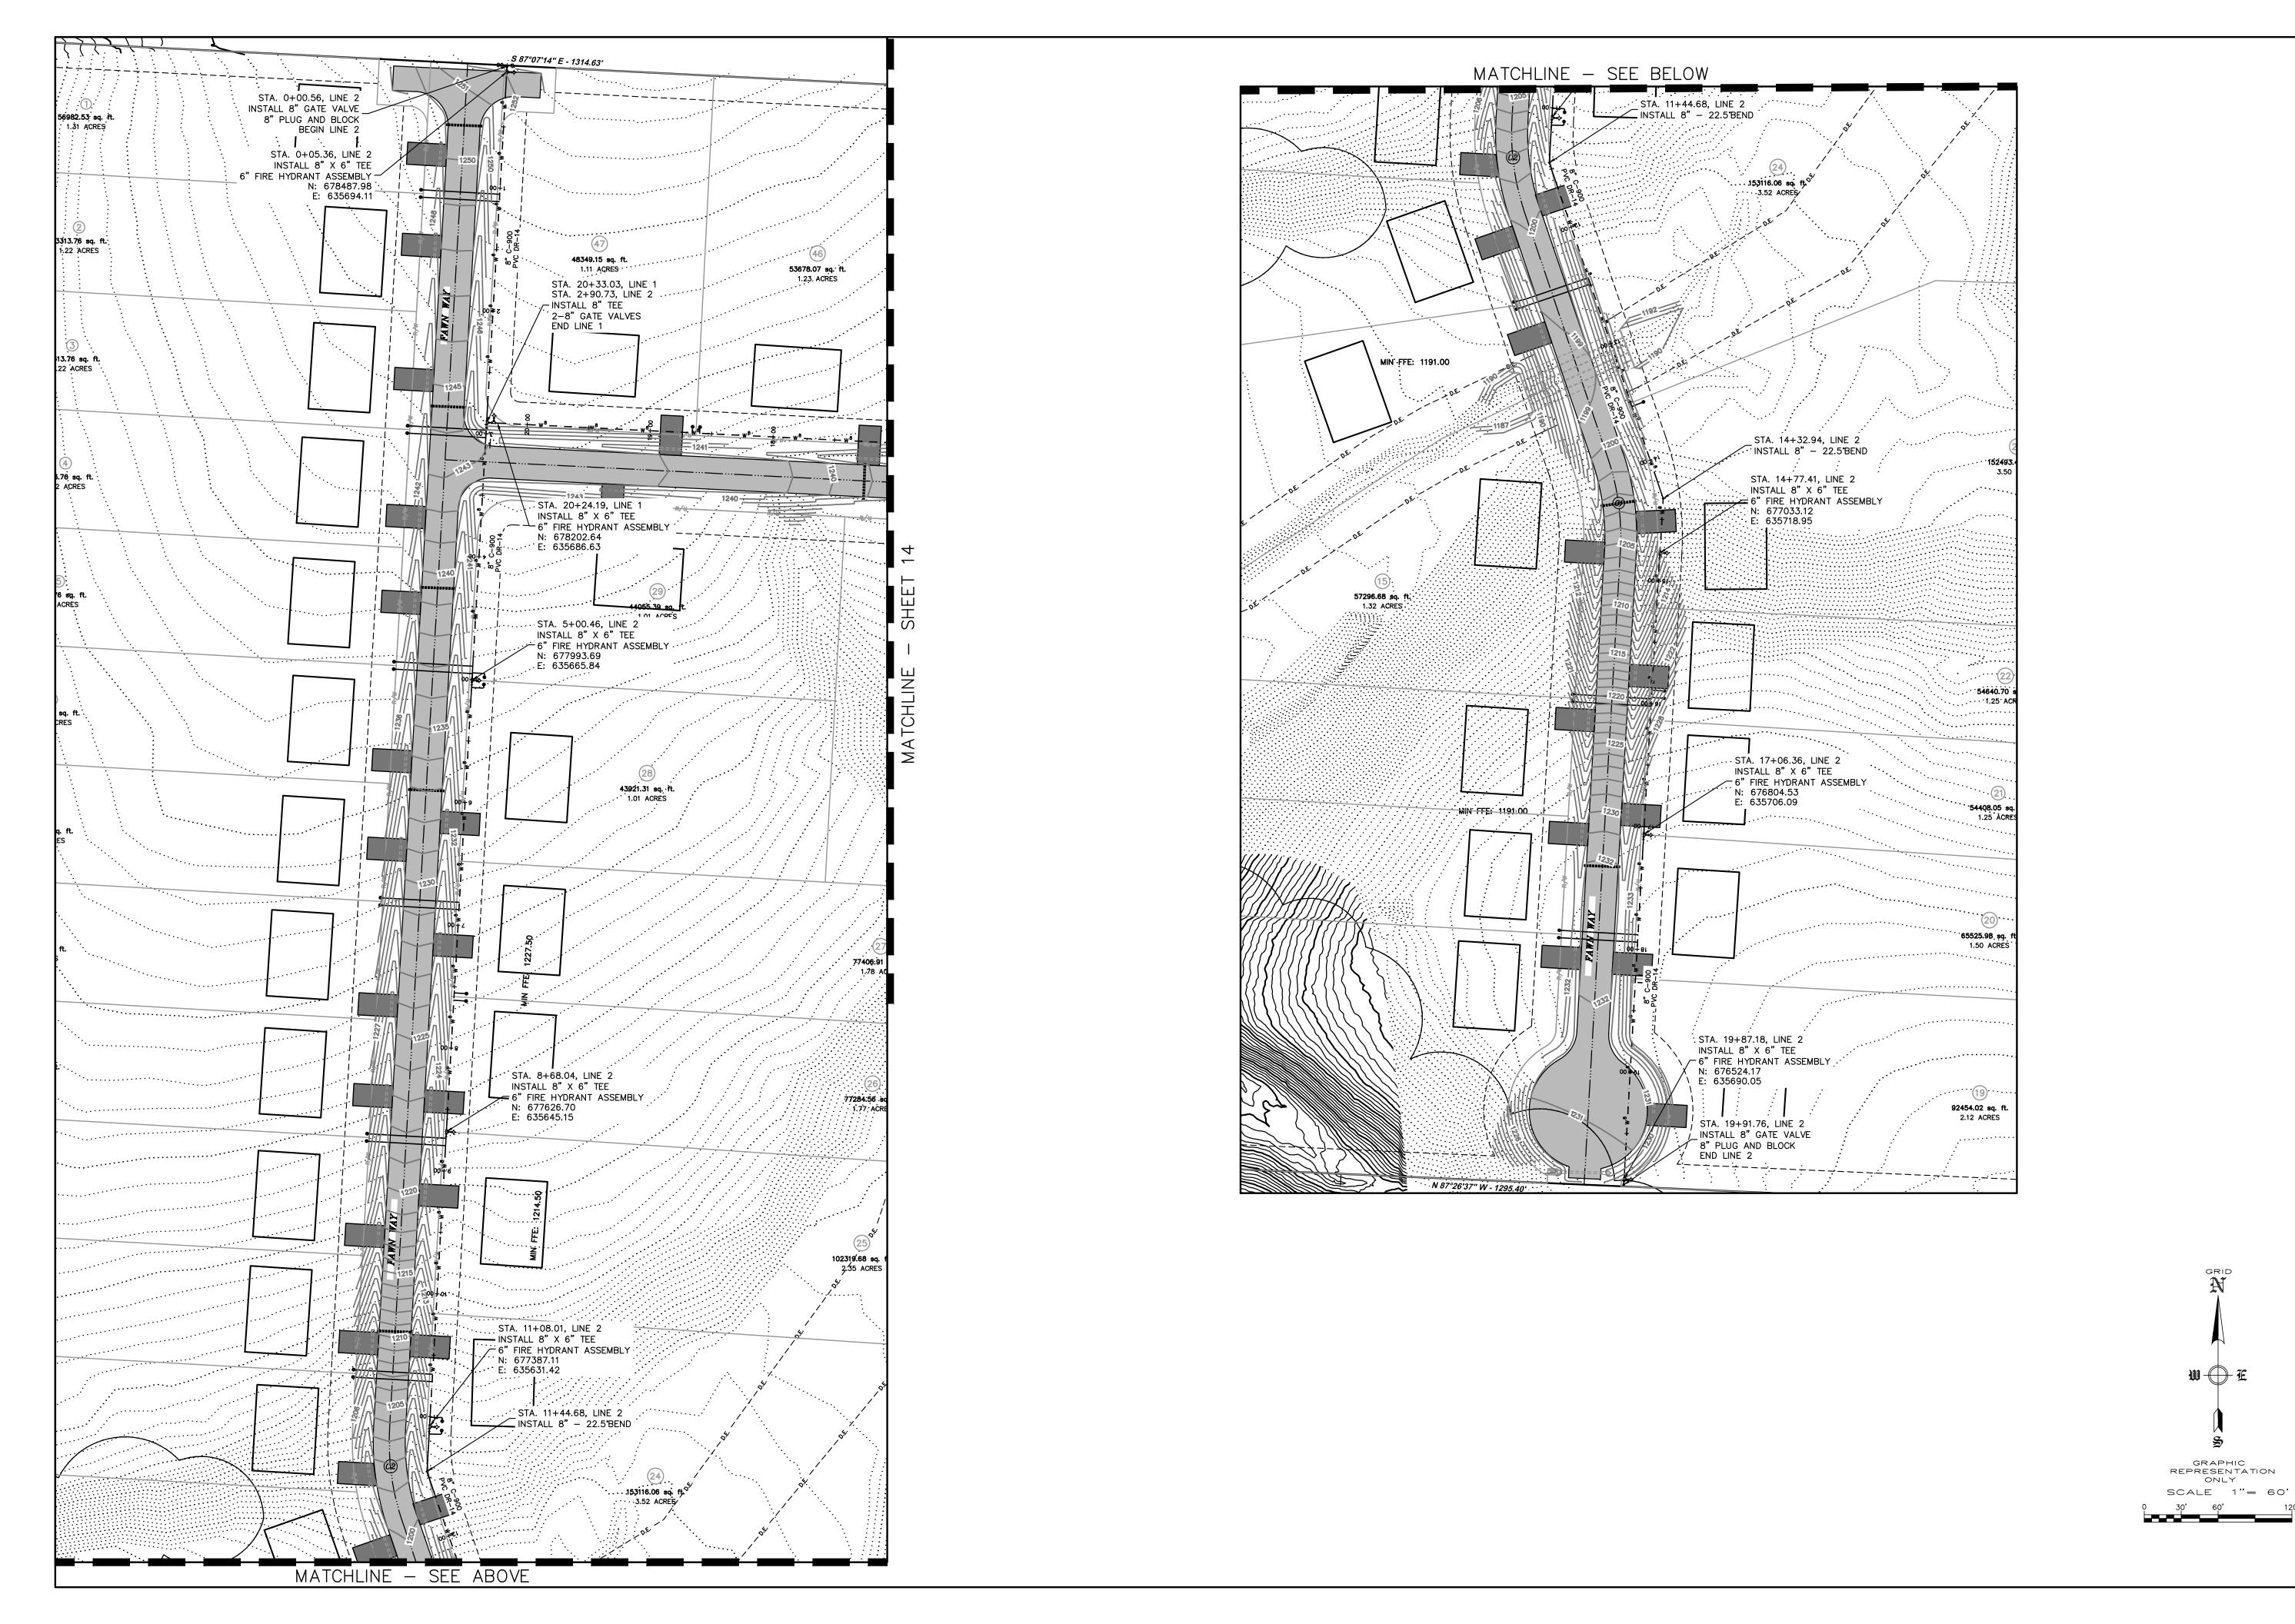


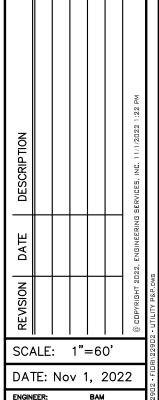

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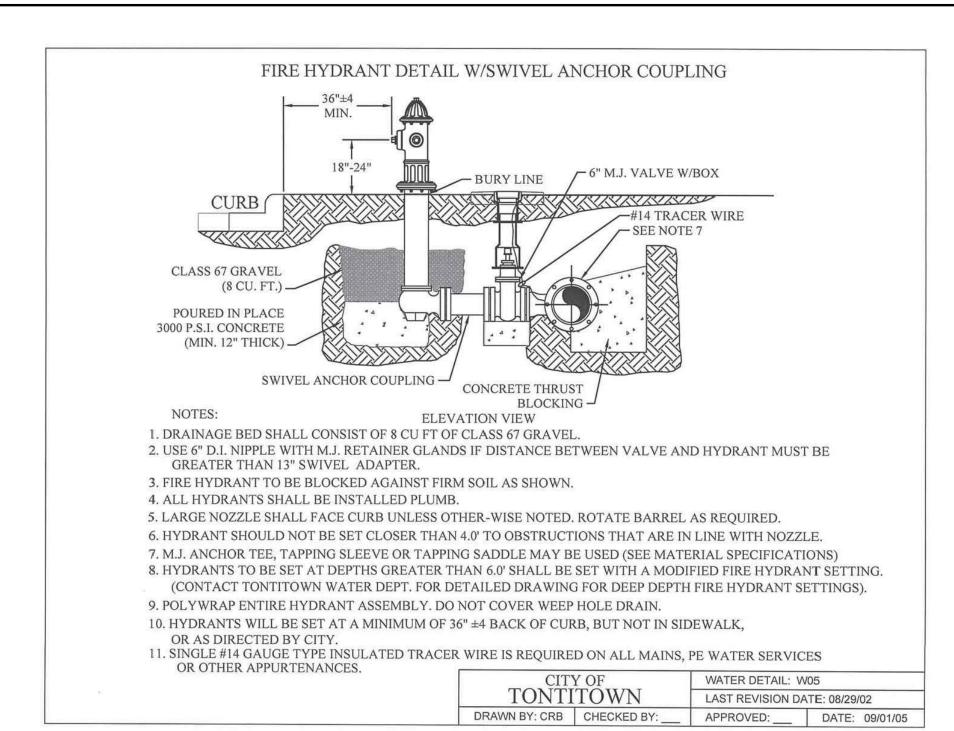
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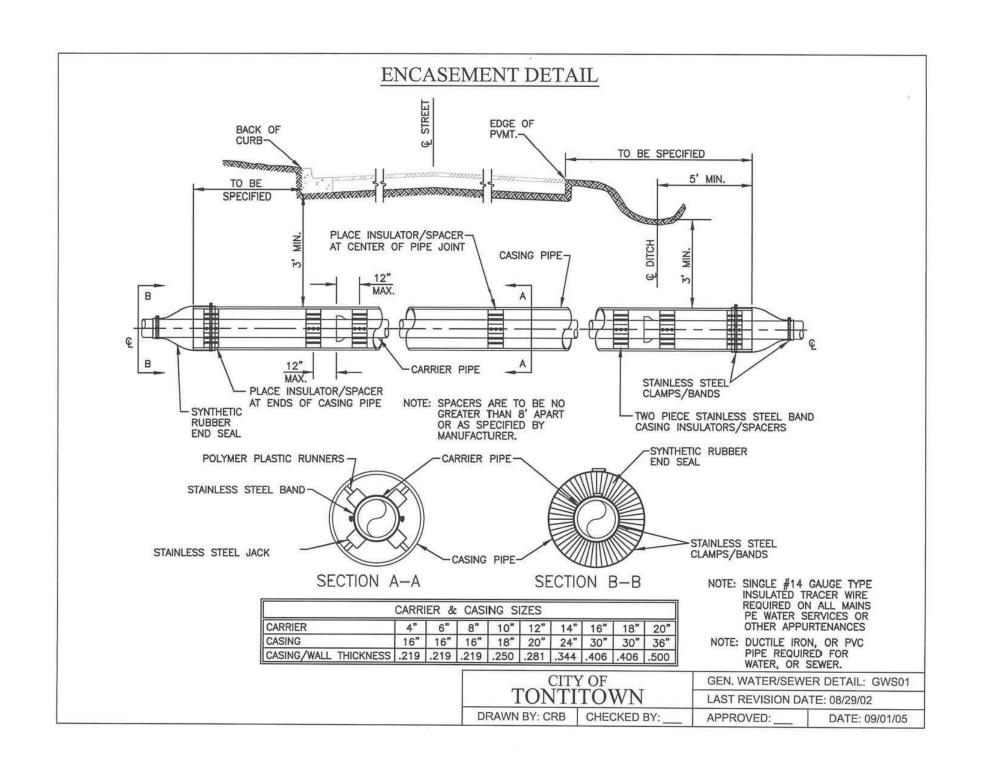


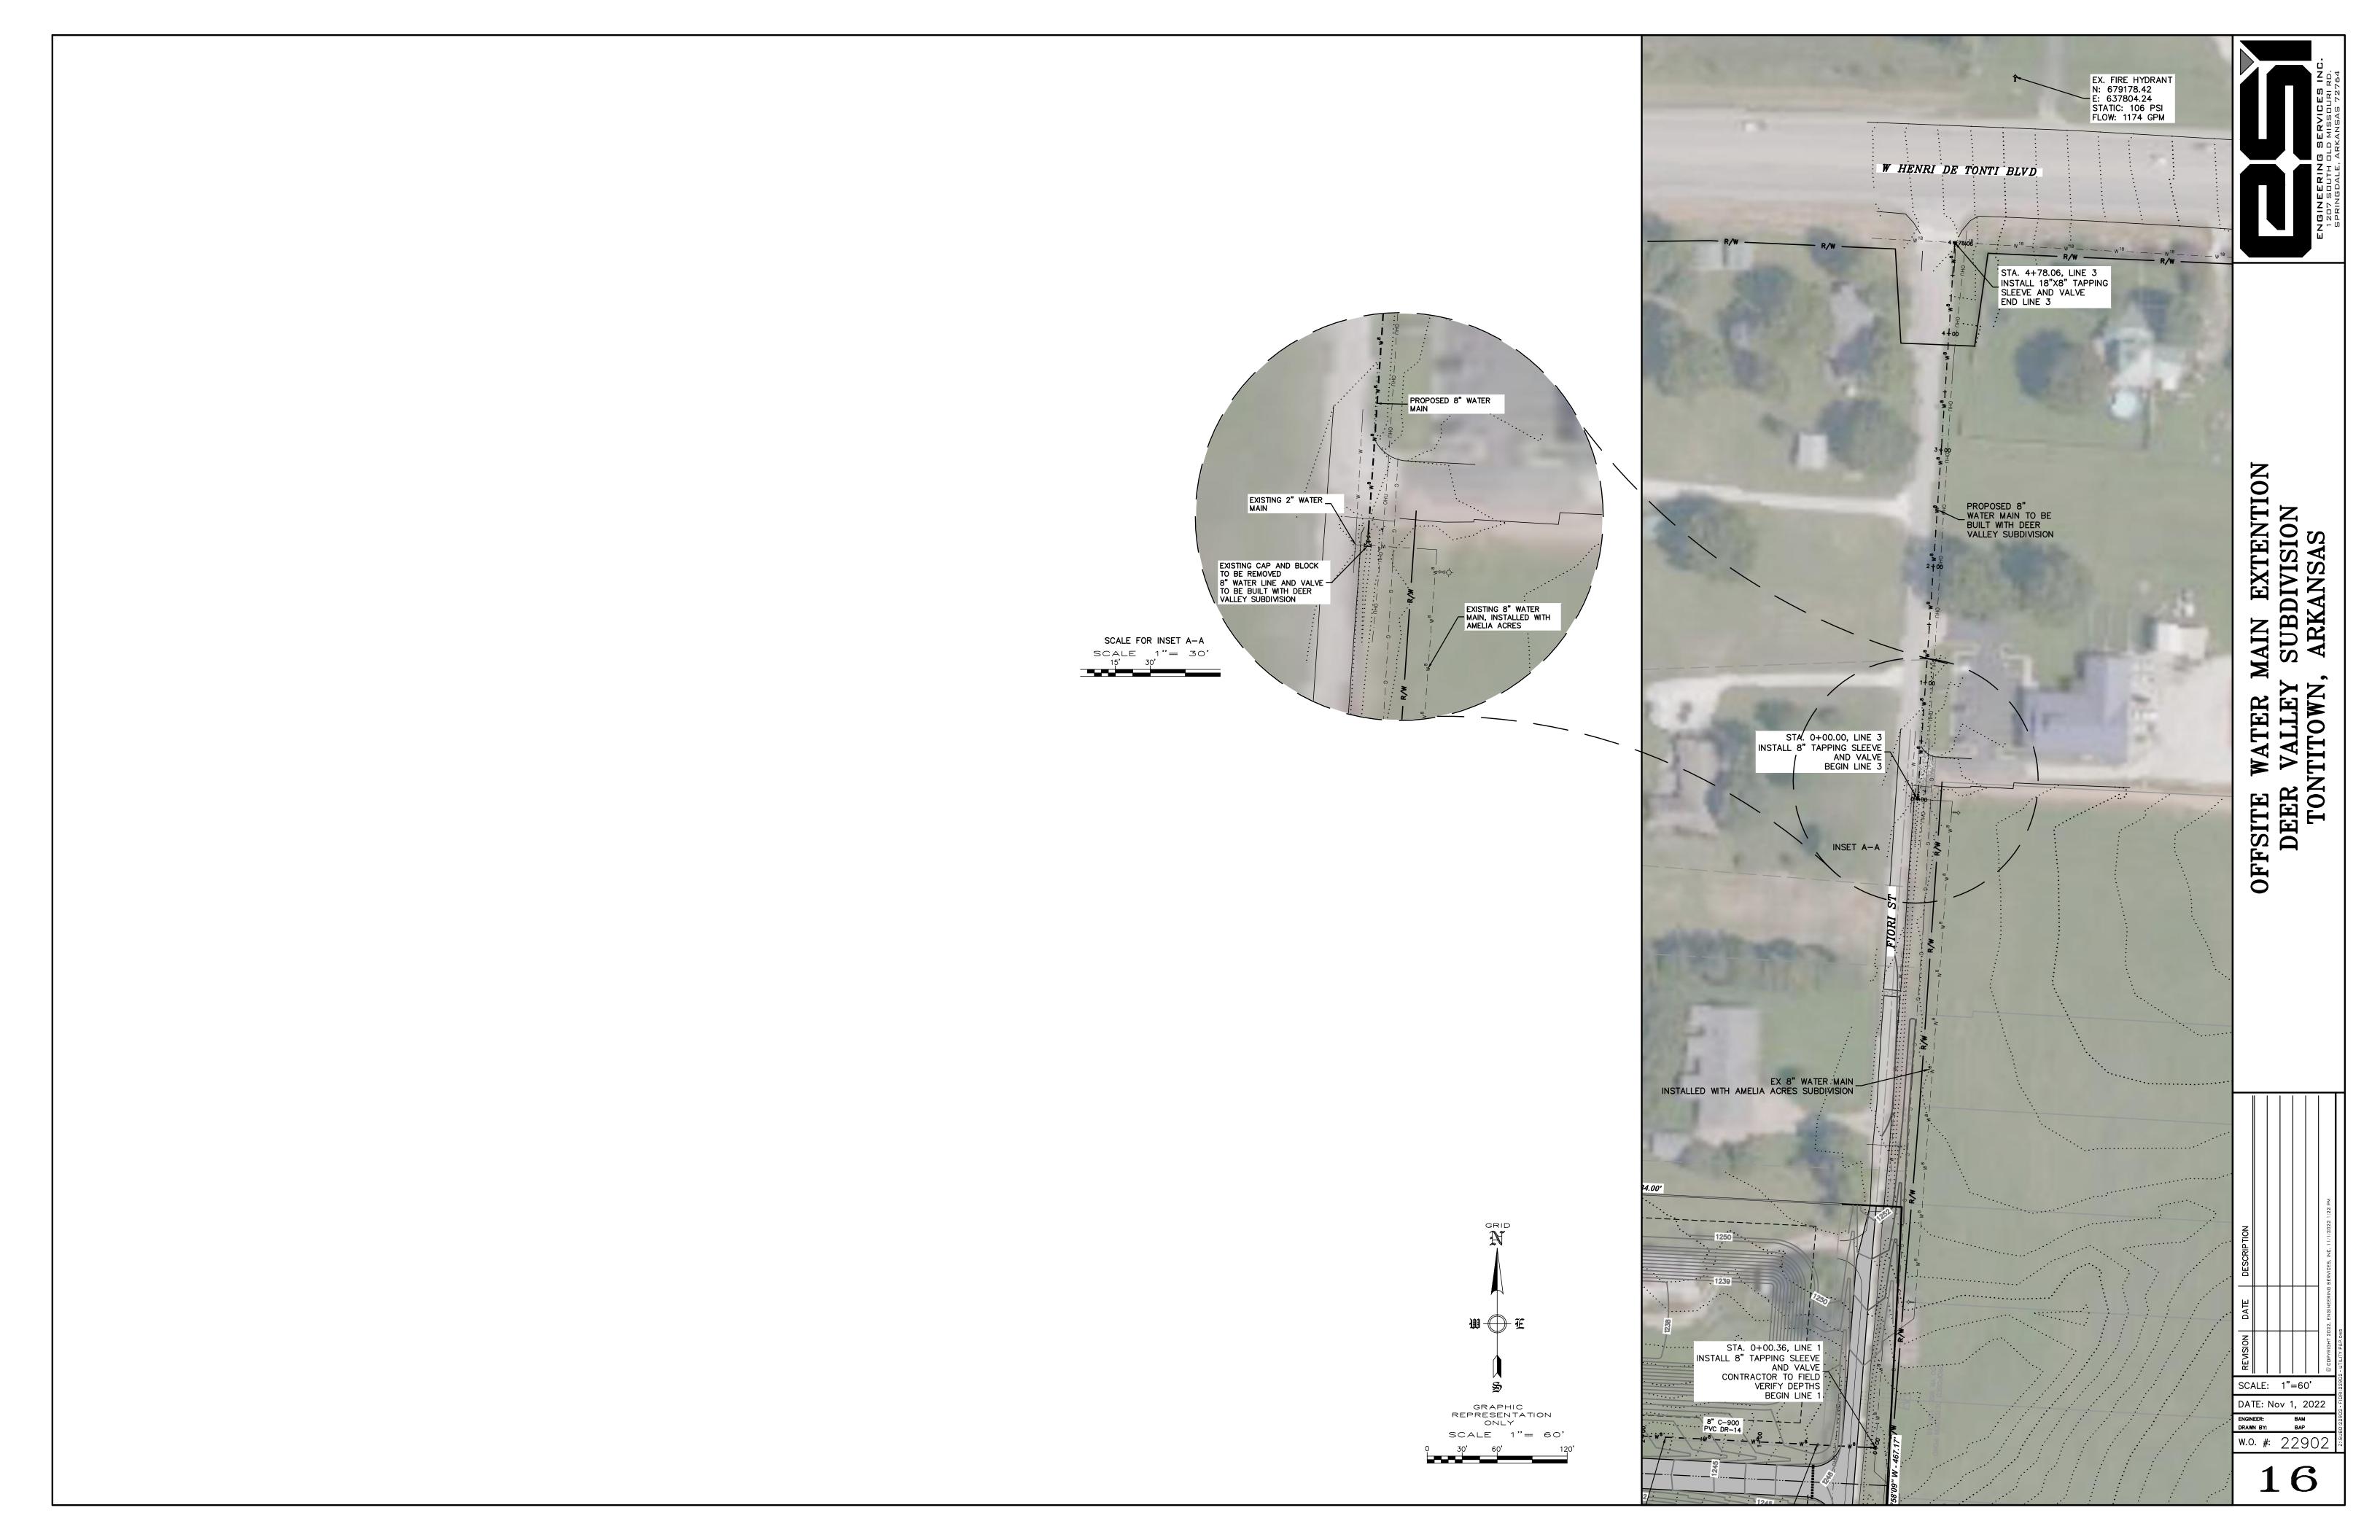



- 2. USE 6" D.I. NIPPLE WITH M.J. RETAINER GLANDS IF DISTANCE BETWEEN VALVE AND HYDRANT MUST BE GREATER THAN 13" SWIVEL ADAPTER.
- 3. FIRE HYDRANT TO BE BLOCKED AGAINST FIRM SOIL AS SHOWN.
- 4. ALL HYDRANTS SHALL BE INSTALLED PLUMB.
- 5. LARGE NOZZLE SHALL FACE CURB UNLESS OTHER-WISE NOTED. ROTATE BARREL AS REQUIRED.
- 6. HYDRANT SHOULD NOT BE SET CLOSER THAN 4.0' TO OBSTRUCTIONS THAT ARE IN LINE WITH NOZZLE.
- 7. M.J. ANCHOR TEE, TAPPING SLEEVE OR TAPPING SADDLE MAY BE USED (SEE MATERIAL SPECIFICATIONS)
 8. HYDRANTS TO BE SET AT DEPTHS GREATER THAN 6.0' SHALL BE SET WITH A MODIFIED FIRE HYDRANT SETTING.
 (CONTACT TONTITOWN WATER DEPT. FOR DETAILED DRAWING FOR DEEP DEPTH FIRE HYDRANT SETTINGS).
- 9. POLYWRAP ENTIRE HYDRANT ASSEMBLY. DO NOT COVER WEEP HOLE DRAIN.
- 10. HYDRANTS WILL BE SET AT A MINIMUM OF 36" ±4" BACK OF CURB, BUT NOT IN SIDEWALK,
- OR AS DIRECTED BY CITY.
- 11. SINGLE #14 GAUGE TYPE INSULATED TRACER WIRE IS REQUIRED ON ALL MAINS, PE WATER SERVICES
- OR OTHER APPURTENANCES.

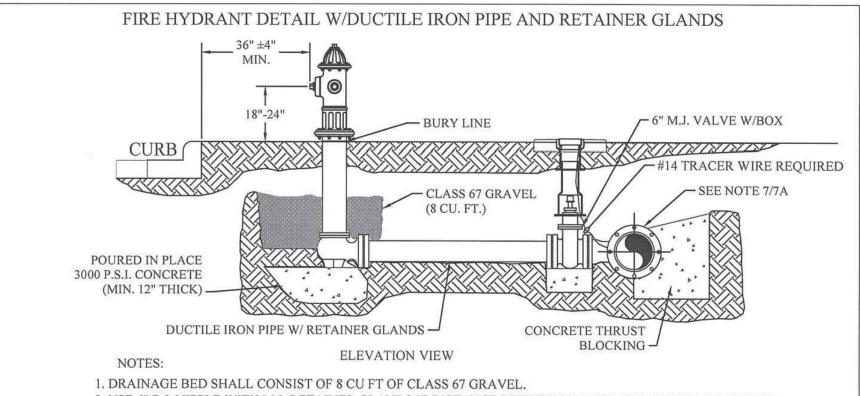
| | Y OF | WATER DETAIL: W04 | | |
|---------------|-------------|------------------------------|----------------|--|
| TONTITOWN | | LAST REVISION DATE: 08/29/02 | | |
| DRAWN BY: CRB | CHECKED BY: | APPROVED: | DATE: 09/01/05 | |





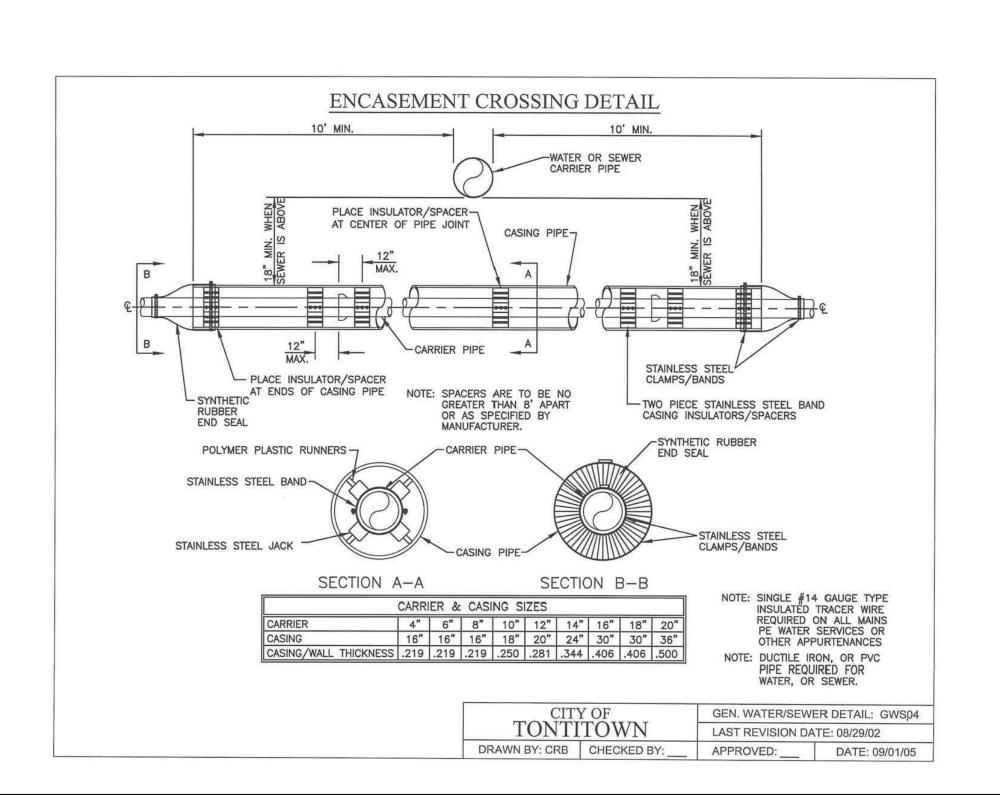

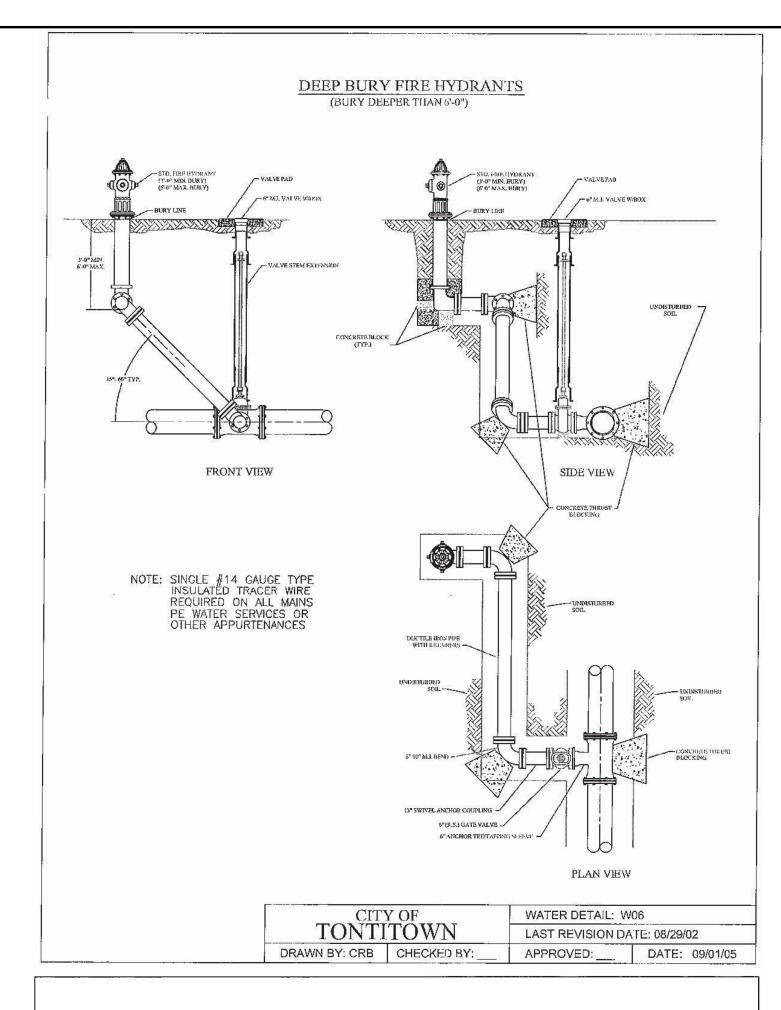

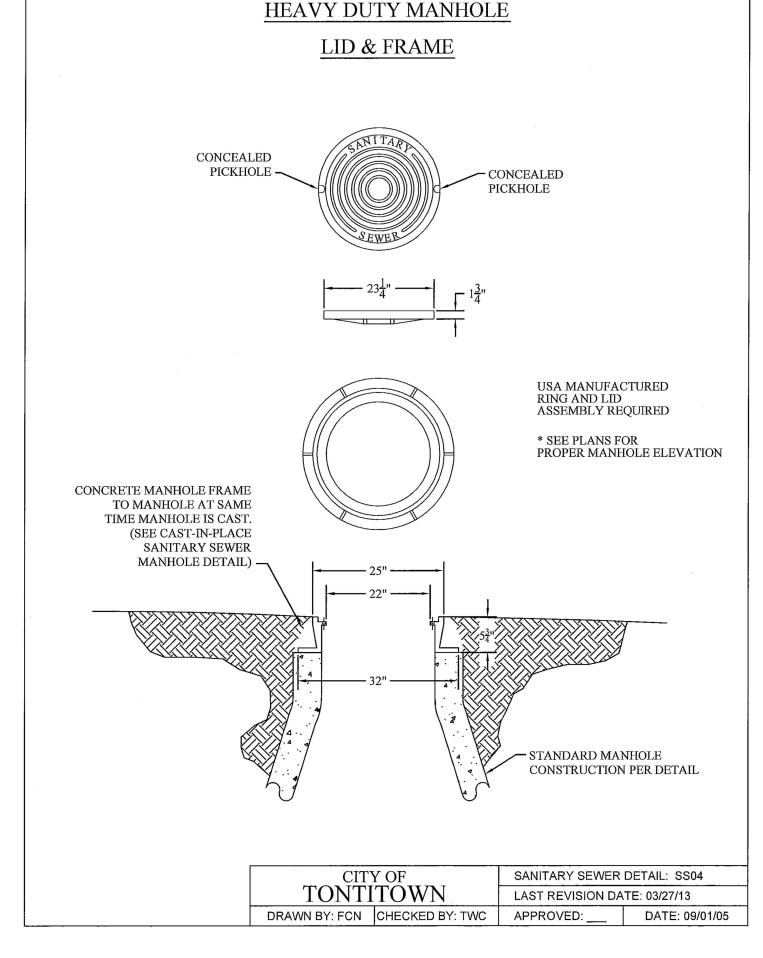



DETAILS IVISION ANSAS

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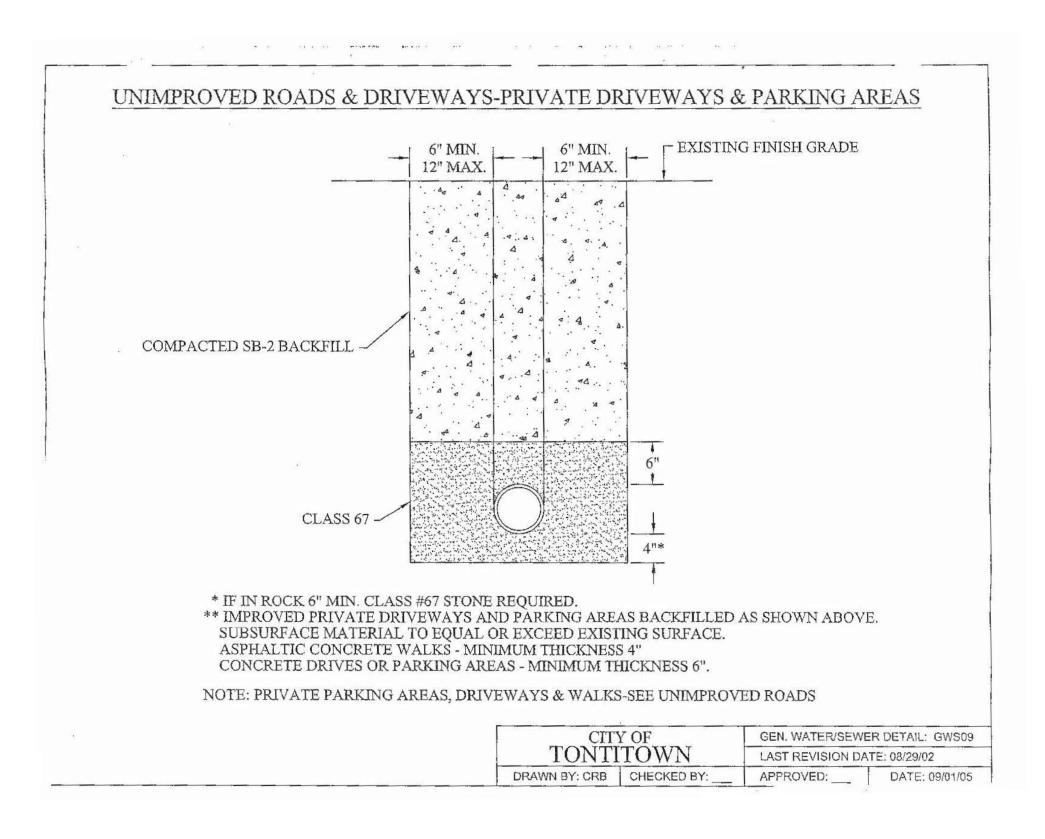
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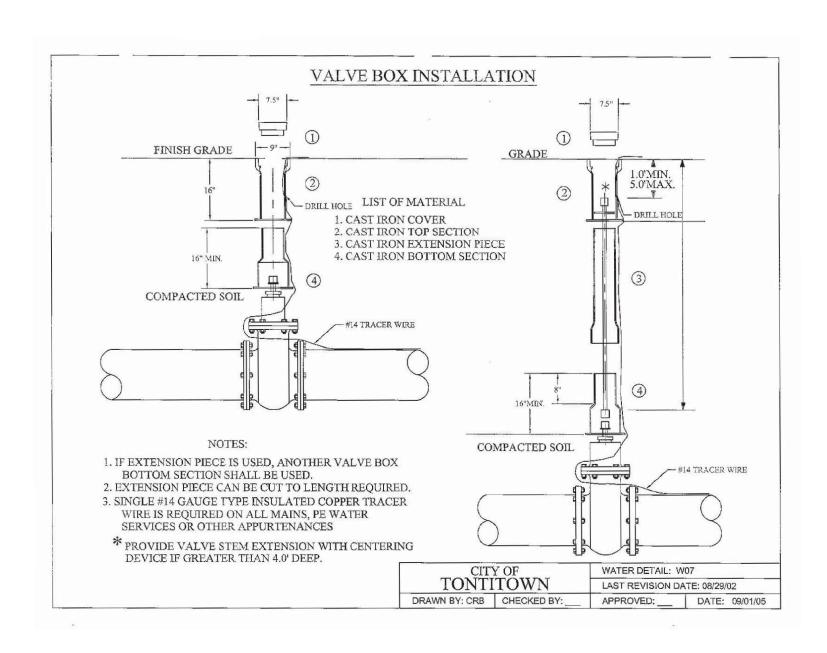
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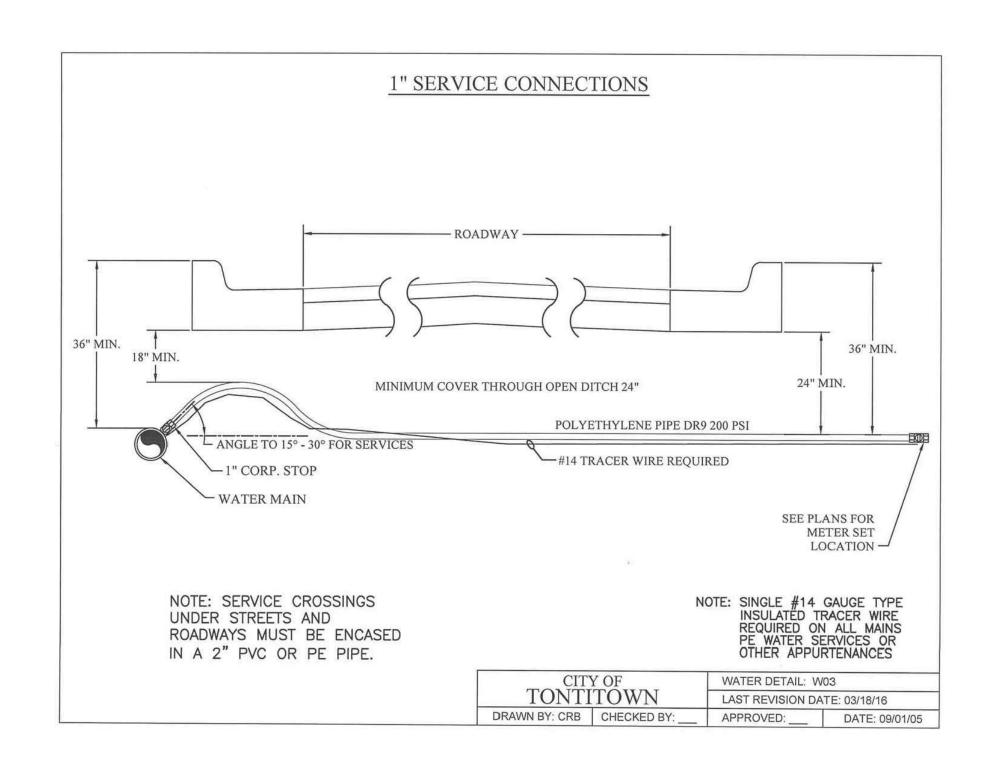
SCALE: NTS


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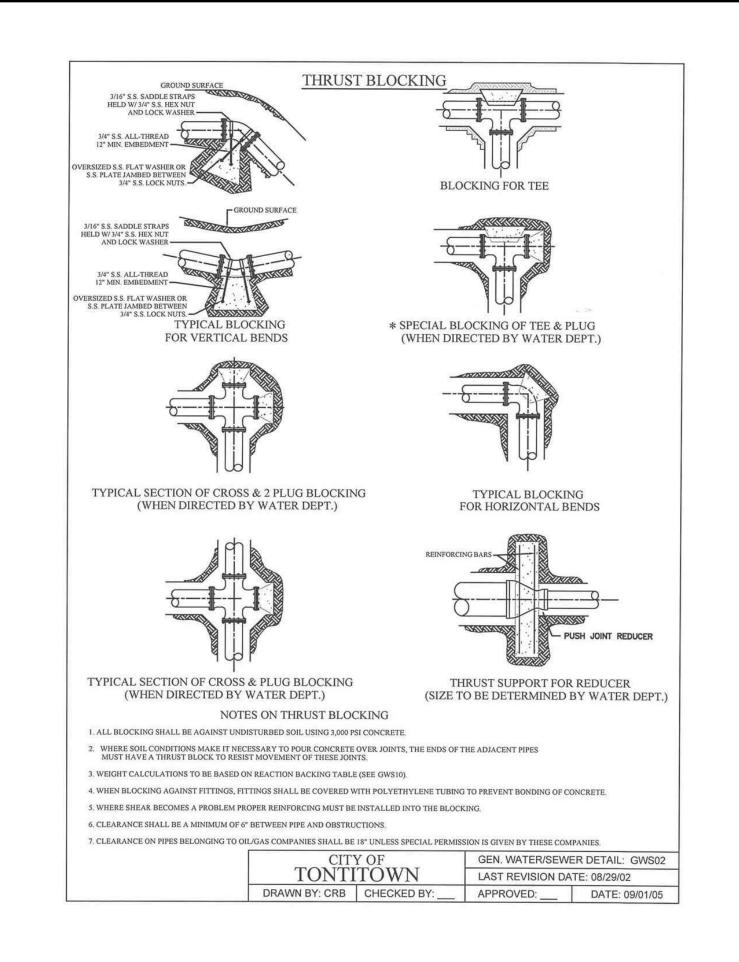
w.o. #: 22902












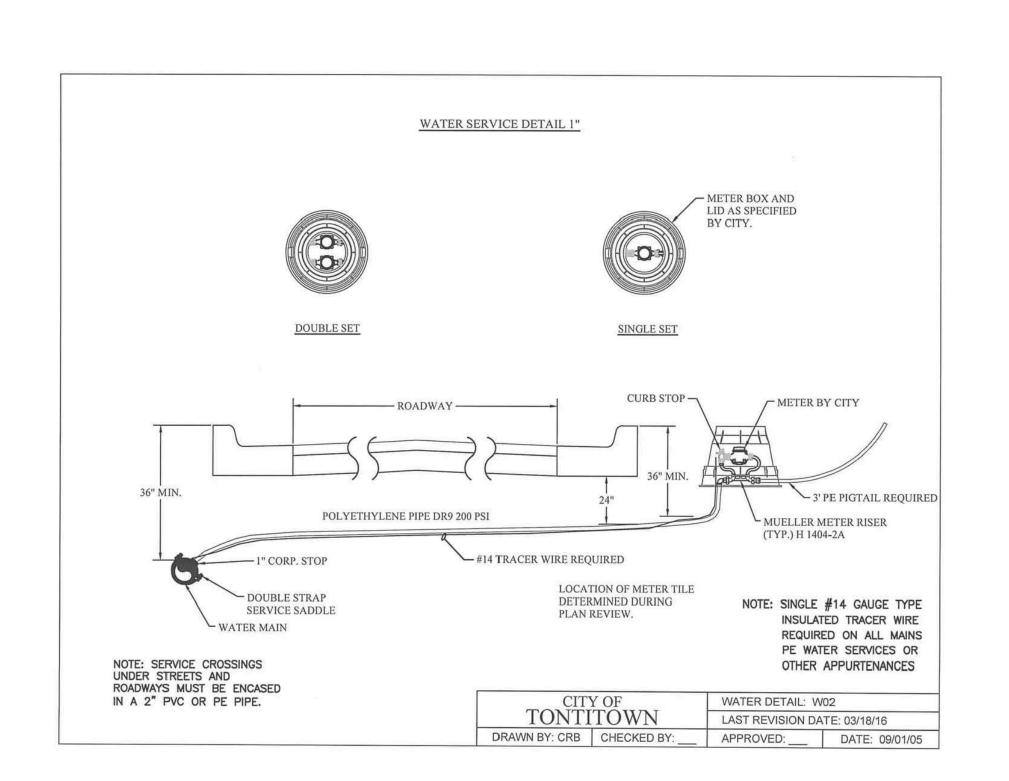


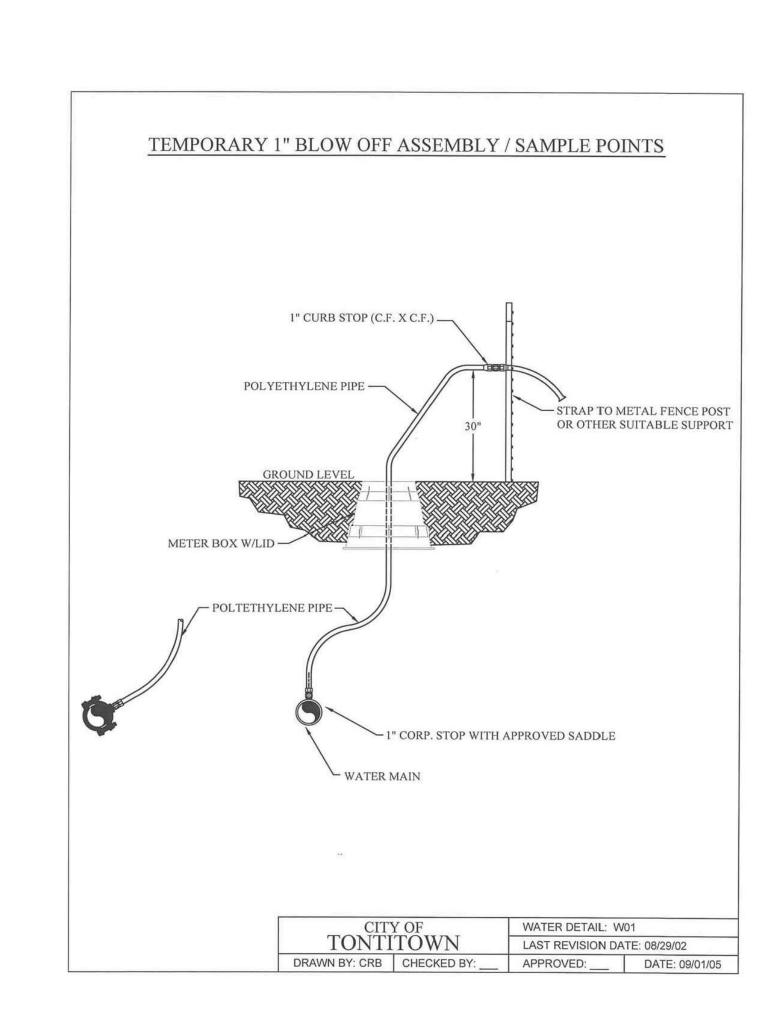


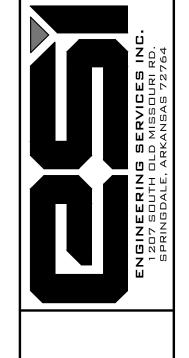



WATER AND SEWER DETAILS DEER VALLEY SUBDIVISION TONTITOWN, ARKANSAS

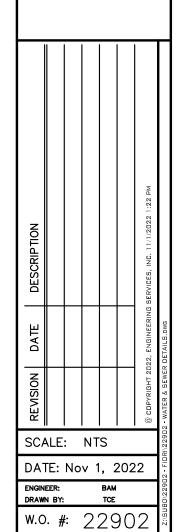


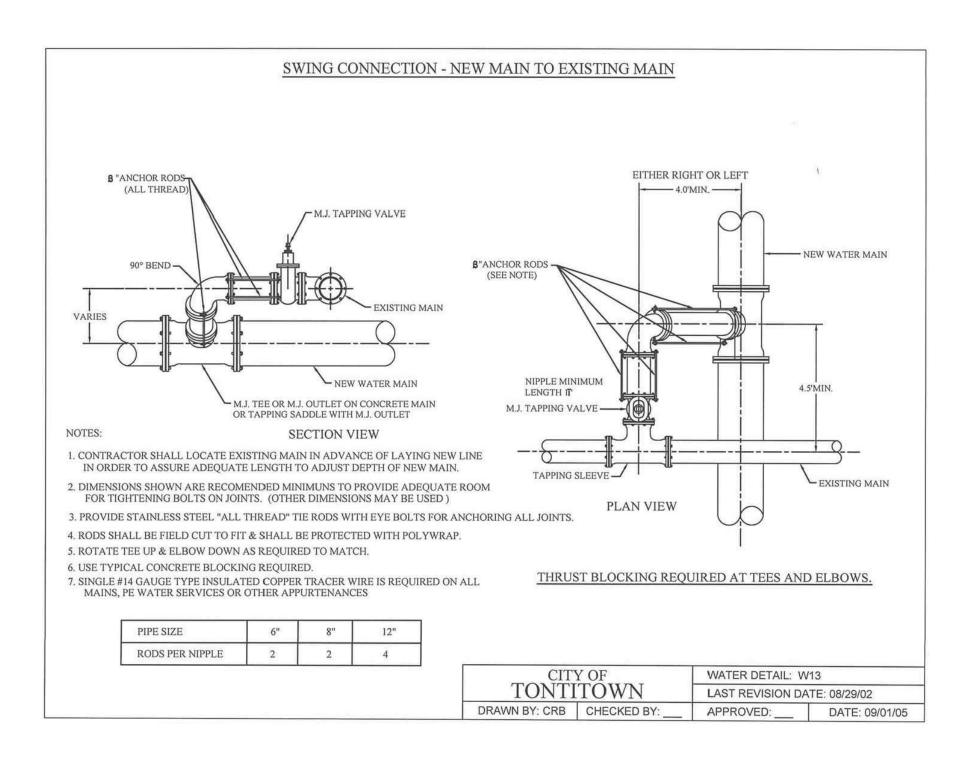


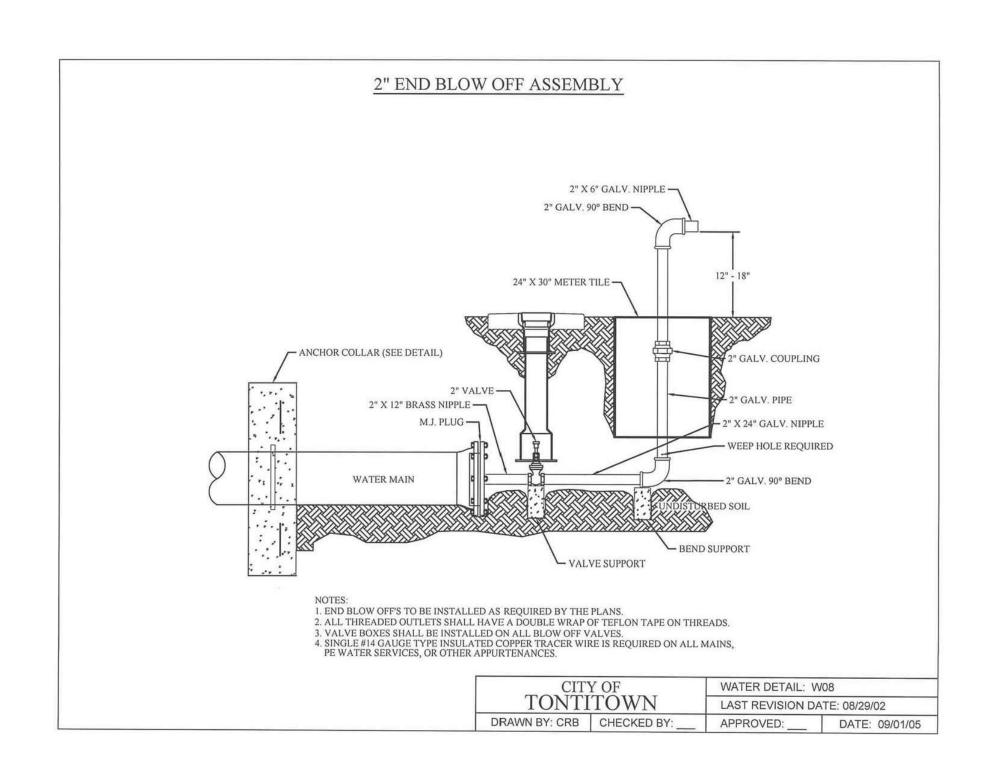

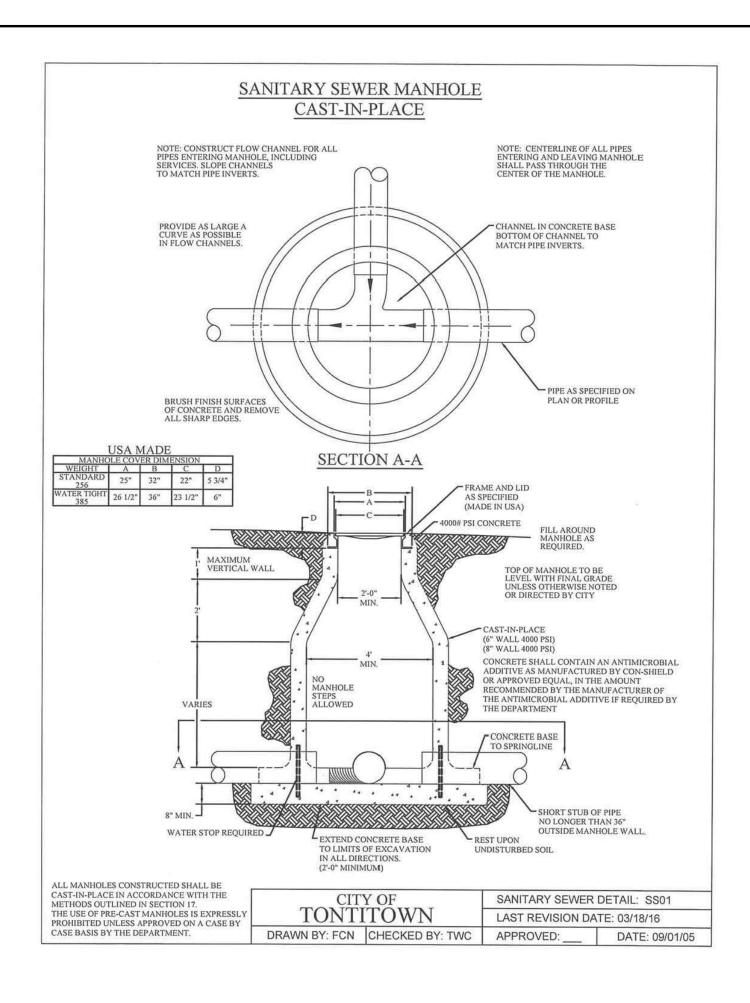

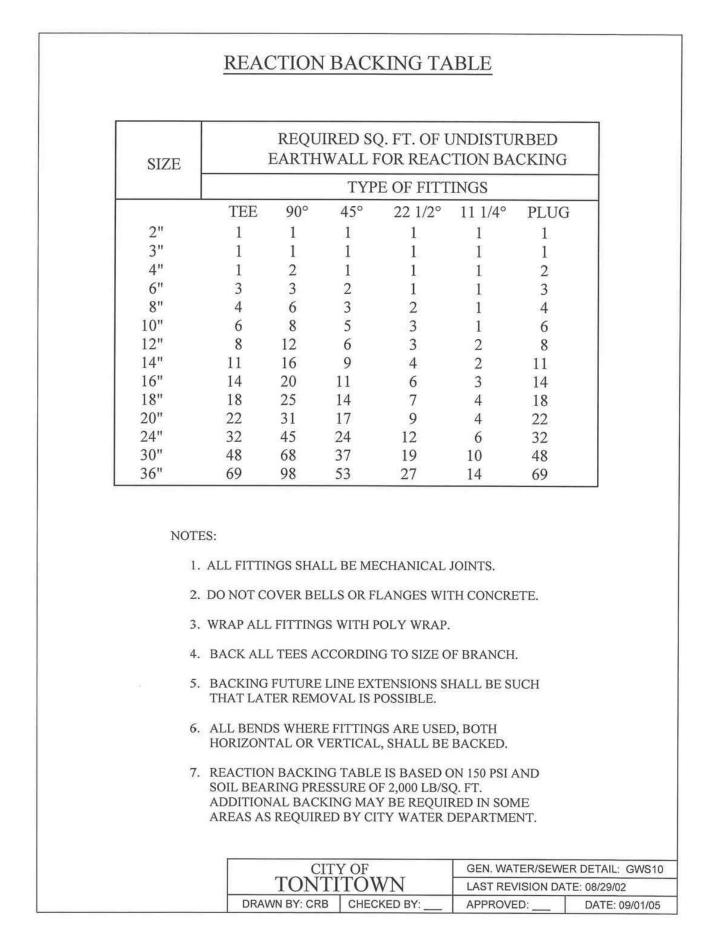

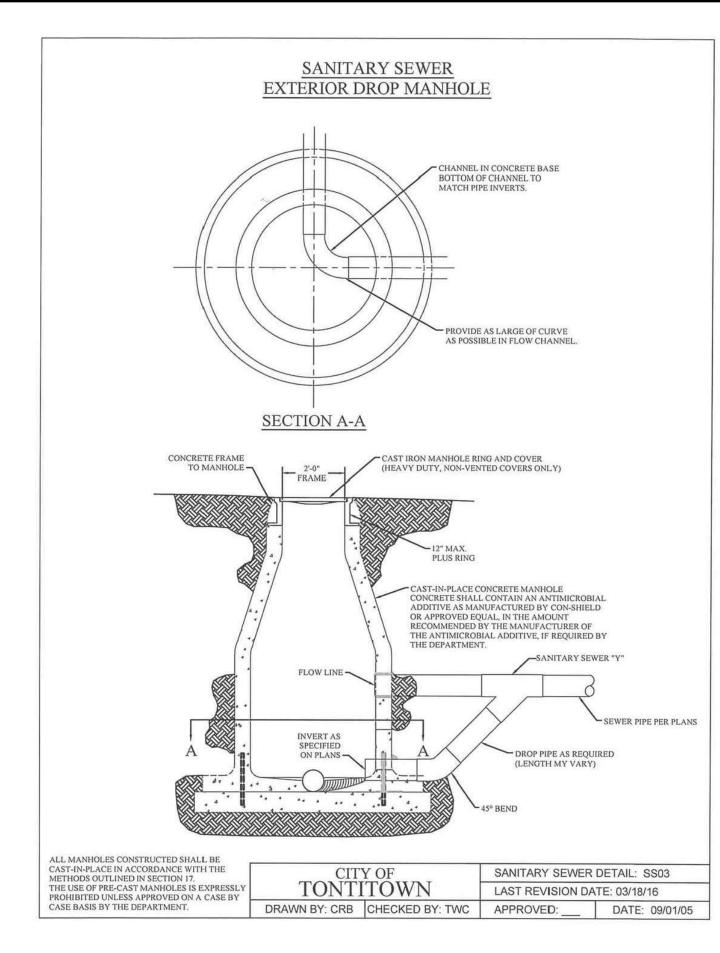


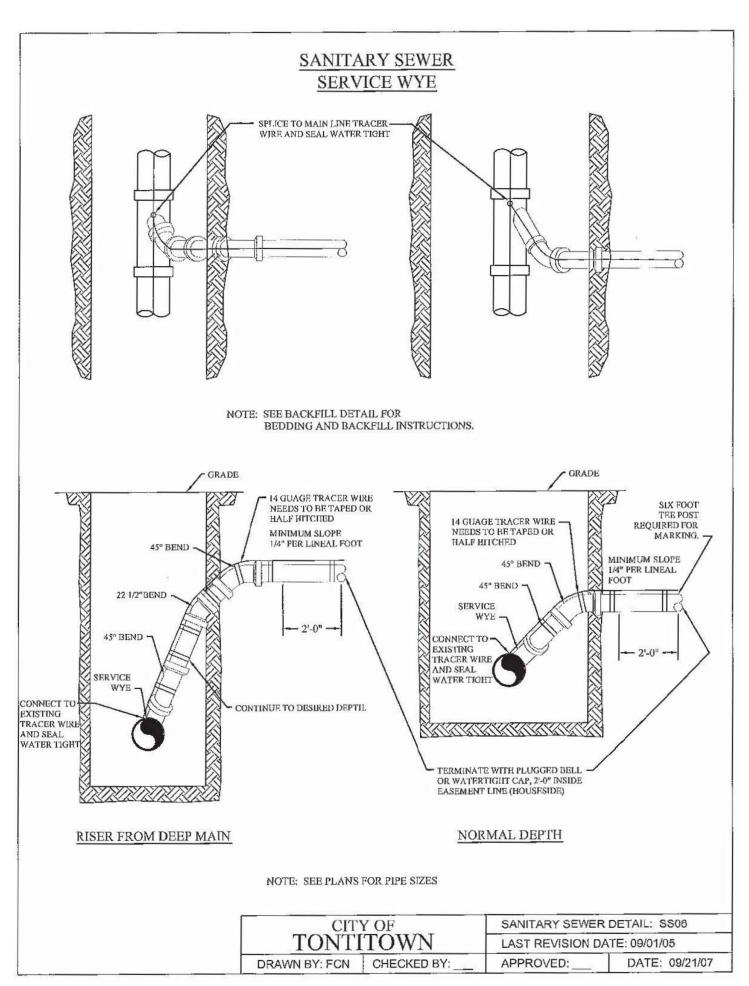






EWER DETAILS SUBDIVISION ARKANSAS SEWER DEER VALLEY TONTITOWN,

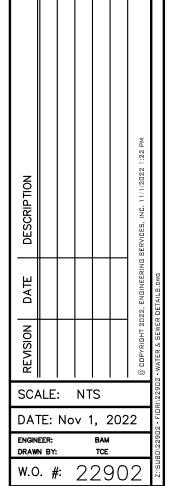

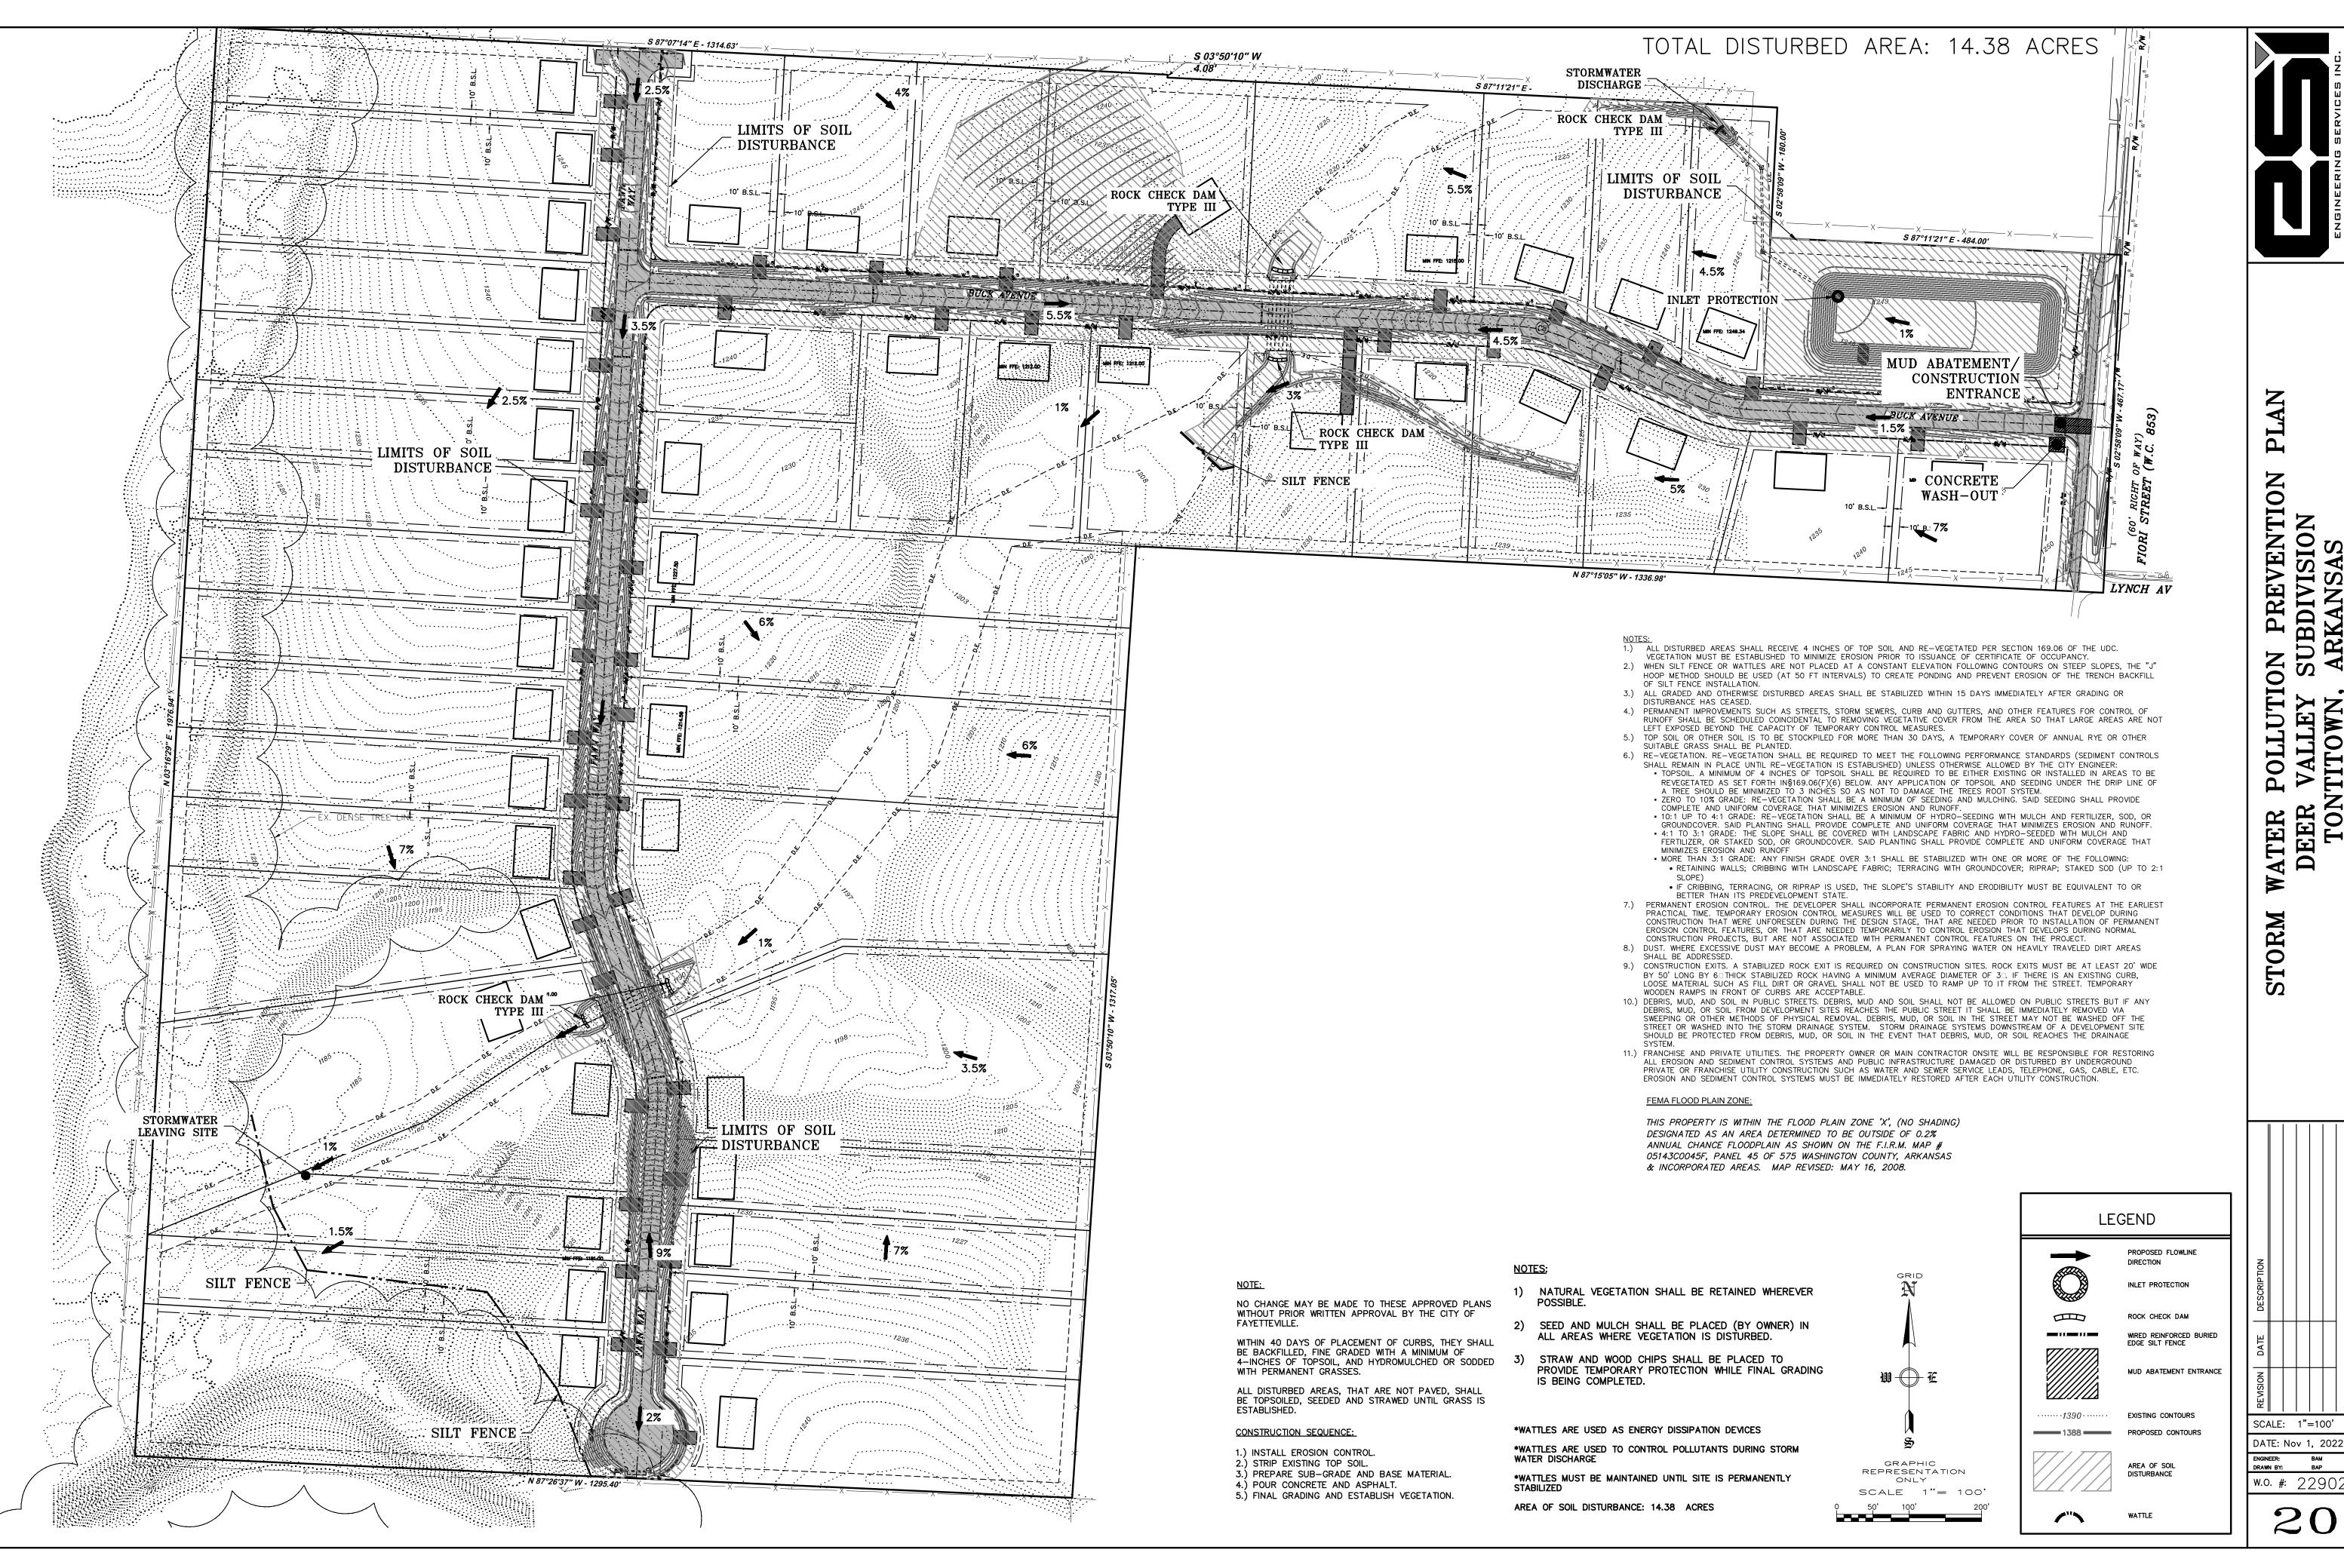

PREVENTIC JBDIVISION RKANSAS ATER POLLUTI DEER VALLEY TONTITOWN,

SCALE: 1"=100' DATE: Nov 1, 2022

0

SCALE: NTS DATE: Nov 1, 2022

w.o. #: 22902

<u>SECTION A - A</u>

PLASTIC — LINING

 \bigcirc

<u>PLAN</u>

LATH AND FLAGGING SHOULD BE COMMERCIAL TYPE.

CONCRETE WASH-OUT AREA

Maximum Slope Length for Silt Fence

Silt Fence

THE SLOPE LENGTH SHOWN IS THE DISTANCE FROM THE FENCE TO THE DRAINAGE DIVIDE OR THE NEAREST UPSLOPE CHANNEL.
 SLOPE LENGTH CANNOT BE ADDRESSED BY USE OF MULTIPLE ROWS OF SILT FENCE.

2) PLASTIC LINING MATERIAL SHOULD BE A MINIMUM OF 30 MIL POLYETHYLENE SHEETING AND SHOULD BE FREE OF HOLES, TEARS, OR OTHER DEFECTS THAT COMPROMISE THE IMPERMEABILITY OF THE MATERIAL.

Maximum Slope Length (ft) Above Fence

Standard (18" High) Reinforced (30" High)

Silt Fence

250

250

150 100

55

45 40

35

__ 5' STEEL POST

FENCE

─ 6"x6" TRENCH

6" BURIED END OF FABRIC

SAND BAG — 10' MIN. —

NOTES:


Slope - Percent

10


25

40

LATH AND FLAGGING _ ON ALL SIDES

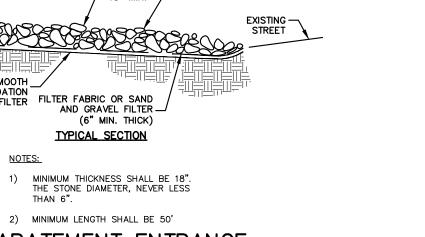

2) MINIMUM LENGTH SHALL BE 50' MUD ABATEMENT ENTRANCE

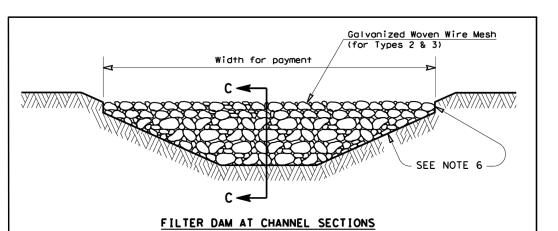



GENERAL NOTES

SMOOTH_ FOUNDATION

1. If shown on the plans or directed by the Engineer, filter dams should be placed near the toe of slopes where erosion is anticipated, upstream and/or downstream at drainage structures, and in roadway ditches and

- Materials (aggregate, wire mesh, sandbags, etc.) shall be as indicated by the specification for "Rock Filter Dams for Erosion and Sedimentation
- 3. The rock filter dom dimensions shall be as indicated on the SW3P plans. 4. Side slopes should be 2:1 or flatter. Dams within the safety zone shall
- have sideslopes of 6:1 or flatter. 5. Maintain a minimum of 1' between top of rock filter dam weir and top of
- embankment for filter dams at sediment traps.
- 6. Filter dams should be embedded a minimum of 4" into existing ground.
- 7. The sediment trap for ponding of sediment laden runoff shall be of the dimensions shown on the plans.
- 8. Rock filter dam types 2 & 3 shall be secured with 20 gauge galvanized woven wire mesh with 1" diameter hexagonal openings. The aggregate shall be placed on the mesh to the height & slopes specified. The mesh shall be folded at the upstream side over the aggregate and tightly secured to itself on the downstream side using wire ties or hog rings. For in stream use, the mesh should be secured or staked to the stream bed prior to aggregate placement.
- 9. Sack Gabions should be staked down with $\frac{3}{4}$ " dia. rebar stakes, and have a double-twisted hexagonal weave with a nominal mesh opening of 2 $\frac{1}{2}$ " x 3 $\frac{1}{4}$ "
- 10. Flow outlet should be onto a stabilized area (vegetation, rock, etc.). 11. The guidelines shown hereon are suggestions only and may be modified by

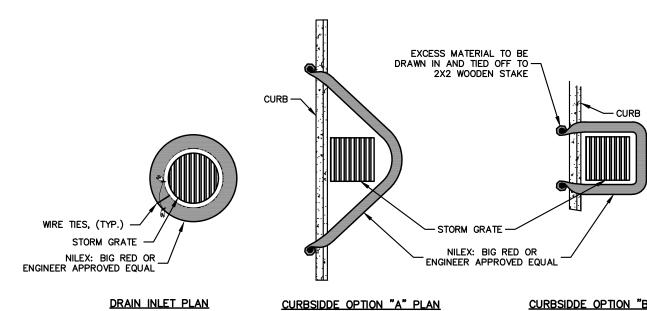

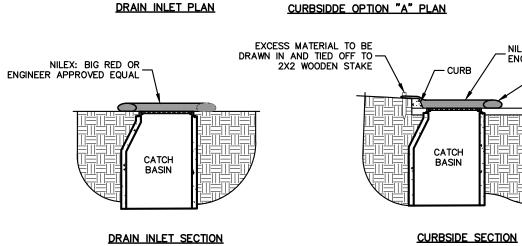

NOTES:) ALL MATERIAL TO MEET SPECIFICATIONS.

CURBSIDDE OPTION "B" PLAN ENGINEER APPROVED EQUAL

SECURE NILEX TO GRATE WITH RUBBER TIE DOWNS

NILEX—BIG RED TO MEET APPLICATION REQUIREMENTS. COMPOST MATERIAL TO BE DISPERSED ON SITE, AS DETERMINED BY ENGINEER.

<u>INLET</u> **PROTECTION** NOT TO SCALE

SILT FENCE NOTES

TIED OR CLIPPED TO FENCE

GEOTEXTILE FABRIC (TYPE 4) IN ACCORDANCE WITH SPECIFICATIONS

- POSTS WHICH SUPPORT THE SILT FENCE SHALL BE INSTALLED ON A SLIGHT ANGLE TOWARD THE ANTICIPATED RUNOFF SOURCE. POST MUST BE EMBEDDED A MINIMUM OF ONE FOOT.
- 2. THE TOE OF THE SILT FENCE SHALL BE TRENCHED IN WITH A SPADE OR MECHANICAL TRENCHER, SO THAT THE DOWNSLOPE FACE OF THE TRENCH IS FLAT AND PERPENDICULAR TO THE LINE OF FLOW. HERE FENCE CANNOT BE TRENCHED IN (e.g.PAVEMENT), WEIGHT FABRIC FLAP WITH ROCK ON UPHILL SIDE TO PREVENT FLOW FROM SEEPING UNDER FENCE.
- THE TRENCH MUST BE A MINIMUM OF 6 INCHES DEEP AND 6 INCHES WIDE TO ALLOW FOR THE SILT FENCE FABRIC TO BE LAID IN THE GROUND AND BACKFILLED WITH COMPACTED MATERIAL.
- 4. SILT FENCE SHOULD BE SECURELY FASTENED TO EACH SUPPORT POST OR TO WOVEN WIRE, WHICH IN TURN IS ATTACHED TO THE FENCE POST. THERE SHALL BE A 3 FOOT OVERLAP, SECURELY FASTENED WHERE ENDS OF FABRIC MEET.
- 5. REPAIR OR REPLACEMENT SHALL BE MADE PROMPTLY AS NEEDED.
- SILT FENCE SHALL BE REMOVED WHEN THE SITE IS COMPLETELY STABILIZED SO AS NOT TO BLOCK OR IMPEDE STORM FLOW OR DRAINAGE.
- 7. ACCUMULATED SILT SHALL BE REMOVED WHEN IT REACHES A DEPTH OF HALF THE HEIGHT OF THE FENCE. THE SILT SHALL BE DISPOSED OF AT AN APPROVED SITE AND IN SUCH A MANNER AS TO NOT CONTRIBUTE TO ADDITIONAL SILTATION.

WIRED REINFORCED BURIED